## CLIENT: NIUA, DLB and Nagar Palika Bagru

## PROJECT NAME: BAGRU - Faecal Sludge Treatment Plant

LOCATION: BAGRU, RAJASTHAN

	INDEX TO	DRAWINGS:	VICINITY MAP	LOCATION MAP
SHT NO.	DWG NO.	DESCRIPTION		PROJECT SITE
01	BAGRU/FSTP/CD/MP	MASTER PLAN	5	
02	BAGRU/FSTP/CD/HP	HYDRAULIC PROFILE	PROJECT LOCATION PROJECT LOCATION	Posti ESTD
03	BAGRU/FSTP/CD/SC	SCREEN CHAMBER Plan of Screen Chamber, Cross Section of A-A, Cross Section A-A Screen Bar Details @ 1 and Screen Cross Section A-A		Bagru FSTP
04	BAGRU/FSTP/CD/SR-01	STABILIZATION REACTOR:- Plan of SR and Flow Direction of SR		
05	BAGRU/FSTP/CD/SR-02	STABILIZATION REACTOR :- Longitudinal Section @E-E and Manhole Layout Plan		
06	BAGRU/FSTP/CD/SR-03	STABILIZATION REACTOR :- Cross Section @A-A, Cross Section @B-B,Cross Section @C-C Cross Section @D-D	\\	GPS CO-ORDINATES: N=26°48'28.23" E= 75°31'28.11"
07	BAGRU/FSTP/CD/SDB-01	SLUDGE DRYING BED :- Plan of SDB	LEGEND	
08	BAGRU/FSTP/CD/SDB-02	SLUDGE DRYING BED :- Cross Section A-A, Cross Section B-B and Cross Section C-C	LEGENDS	S/SYMBOLS
09	BAGRU/FSTP/CD/ISAF-01	INTEGRATED SETTLER AND ANAEROBIC FILTER:-	GATE VALVE	SUPPORT WALL
09	BAGRO/F31F/CD/ISAF-01	Plan of Integrated Settler and Anaerobic Filter with Cross Section @A-A	MAN HOLE	SECTION OF A-A
10	BAGRU/FSTP/CD/ISAF-02	INTEGRATED SETTLER AND ANAEROBIC FILTER :- Cross Section @A-A and Plan of Manhole	PIPE	V-NOTCH
11	BAGRU/FSTP/CD/PGF	PLANTED GRAVEL FILTER :- Plan of Planted Gravel Filter, Cross Section @A-A and Cross Section @B-B	GAS VENT OPENING	▼ WATER LEVEL
12	BAGRU/FSTP/CD/PP-01	POLISHING POND :- Plan of Polishing Pond	RCC WALL	EXISTING GROUND LEVEL
13	BAGRU/FSTP/CD/PP-02	POLISHING POND :- Cross Section @A-A and Cross Section @ B-B	BRICK WALL	GAS VENT PIPE WITH VENT COWL
14	BAGRU/FSTP/CD/PDB-01	PLANTED DRYING BED:-		
15	BAGRU/FSTP/CD/PDB-02	PLANTED DRYING BED :- Cross Section @A-A and Cross Section @B-B	CINDERS	S.S OPEN CHANNEL GATE
16	BAGRU/FSTP/CD/SSY	SLUDGE STORAGE YARD :- Plan of SSY, Section A-A, Section B-B and Foundation Details	SOLING	OPENING IN WALL
17	BAGRU/FSTP/CD/OR	OPERATOR ROOM :- Front Elevation, Plan of OR and Section A-A	CEMENT CONCRETE FILLING	LANDSCAPE


CLIENT: NIUA, DLB and Nagar Palika Bagru


PROJECT NAME: BAGRU - Faecal Sludge Treatment Plant

LOCATION: BAGRU, RAJASTHAN

	INDEX TO [	PRAWINGS:	VICINITY MAP	LOCATION MAP
SHT NO.	DWG NO.	DESCRIPTION		PROJECT SITE
18	BAGRU/FSTP/CD/GR	GUARD ROOM :- Plan of GR, Front Elevation and Section A-A	<b>E T</b>	
19	BAGRU/FSTP/CD/ROAD	ROAD :- Typical Cross Section of Blacktop Road	PROJECT LOCATION A CONTRACTOR OF THE PROJECT LOCATION	Bagru FSTP
20	BAGRU/FSTP/CD/SC&SR	INTEGRATED SCREEN CHAMBER AND STABILIZATION REACTOR :- Plan of SC&SR, Cross Section @A-A	Sar ,	
21	BAGRU/FSTP/CD/CW	COMPOUND WALL :- Plan of Compound Wall and Cross Section @ A-A		
22	BAGRU/FSTP/CD/RAMP	RAMP :- Plan of RAMP and Cross Section @ A-A	<b>†</b>	是是第一个人的一个人的一个人的一个人的一个人的一个人的一个人的一个人的一个人的一个人的
23	BAGRU/FSTP/CD/RW	RETAINING WALL :- Plan of Retaining wall and Cross Section @ A-A		The same of the last of the la
24	BAGRU/FSTP/CD/SWD-01	STORM WATER DRAING :- Plan of Storm Water Drain		GPS CO-ORDINATES: N=26°48'28.23" E= 75°31'28.11"
25	BAGRU/FSTP/CD/SWD-02	STORM WATER DRAING :- Section of Storm Water Drain	LEGENDS	S/SYMBOLS
26	BAGRU/FSTP/CD/SWT	STORM WATER TANK :- Top plan of Tank, Bottom plan of Section and Section @A-A	GATE VALVE	SUPPORT WALL
27	BAGRU/FSTP/CD/REGISTER		MAN HOLE	SECTION OF A-A
			PIPE	V-NOTCH
			GAS VENT OPENING	WATER LEVEL
			RCC WALL	EXISTING GROUND LEVEL
			BRICK WALL	GAS VENT PIPE WITH VENT COWL
			CINDERS	S.S OPEN CHANNEL GATE
			SOLING	OPENING IN WALL
			CEMENT CONCRETE FILLING	LANDSCAPE



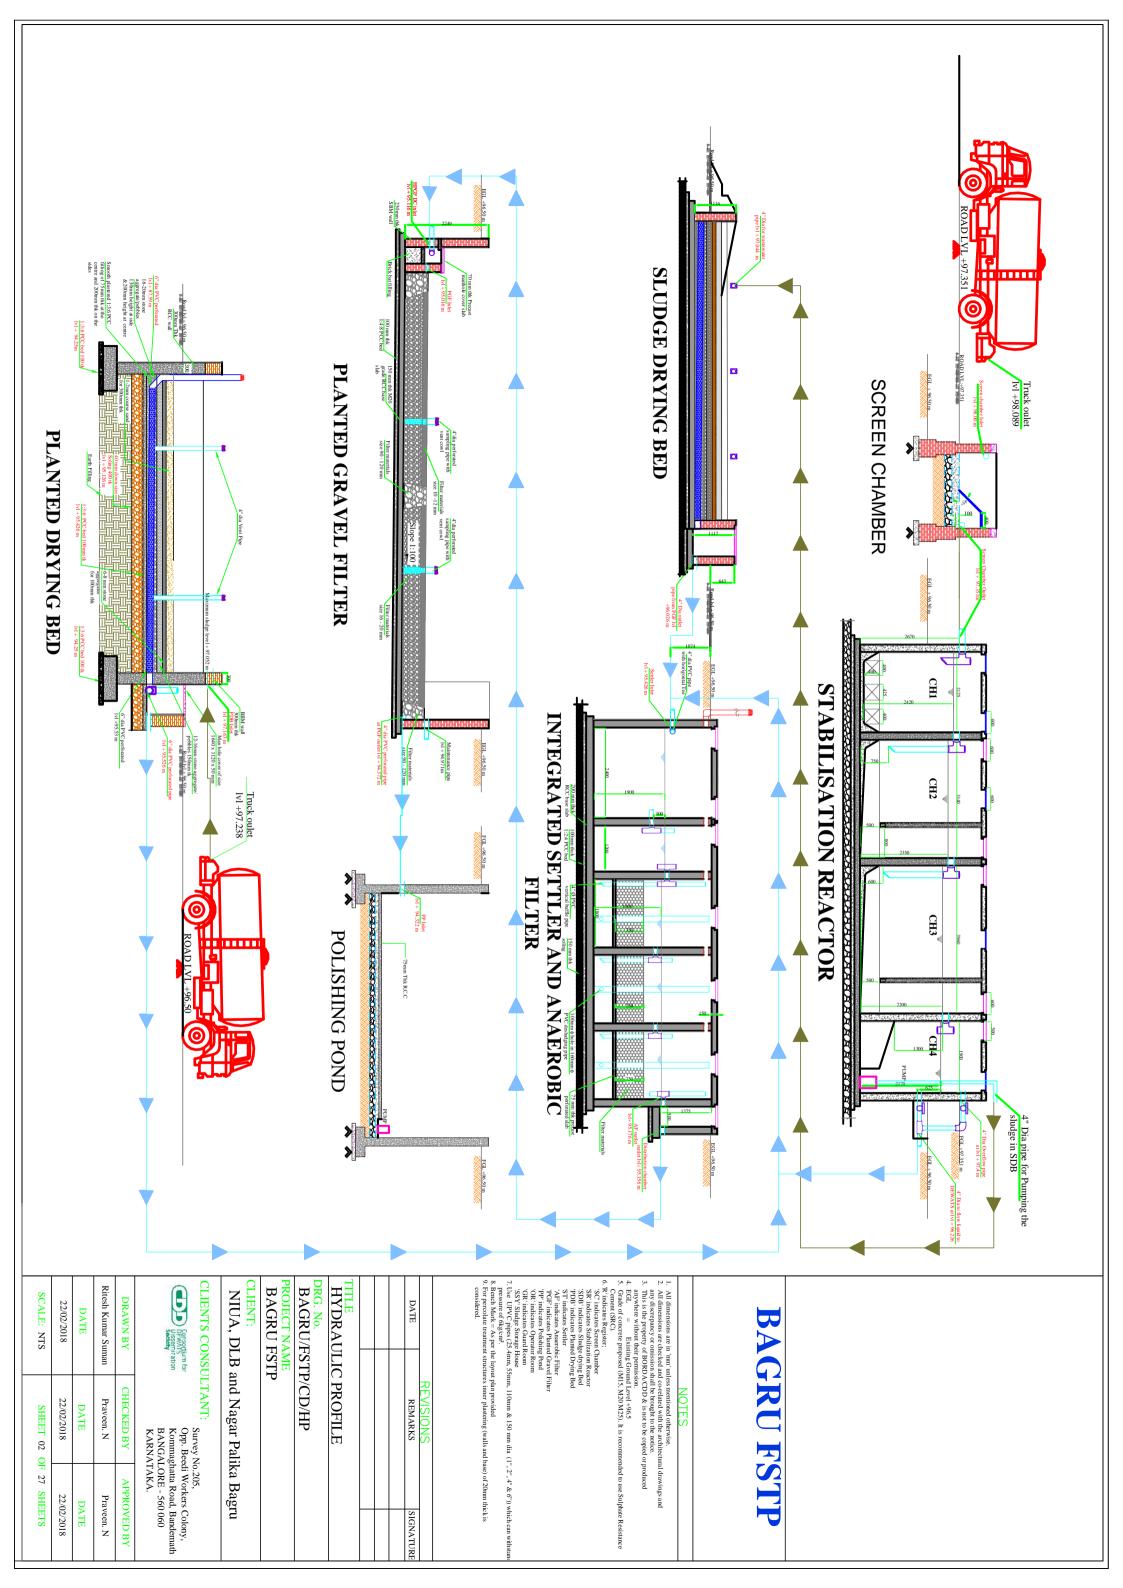


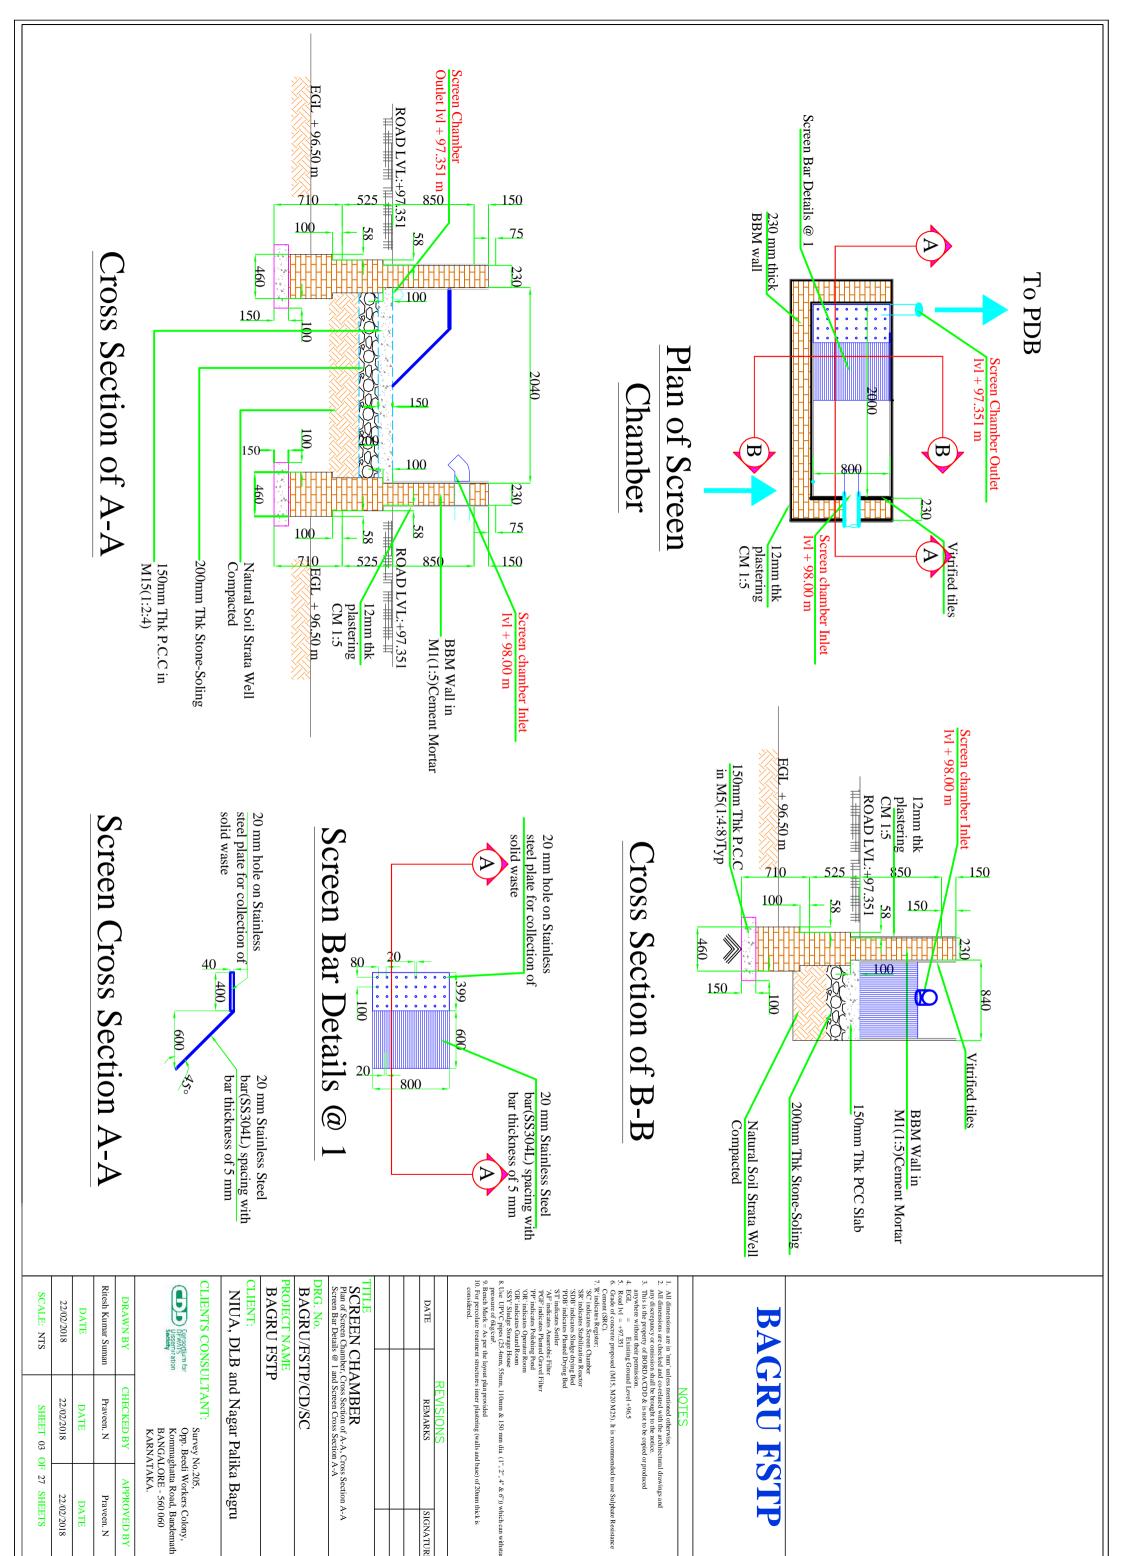

SIGNATURE

Praveen. N

22/02/2018 DATE

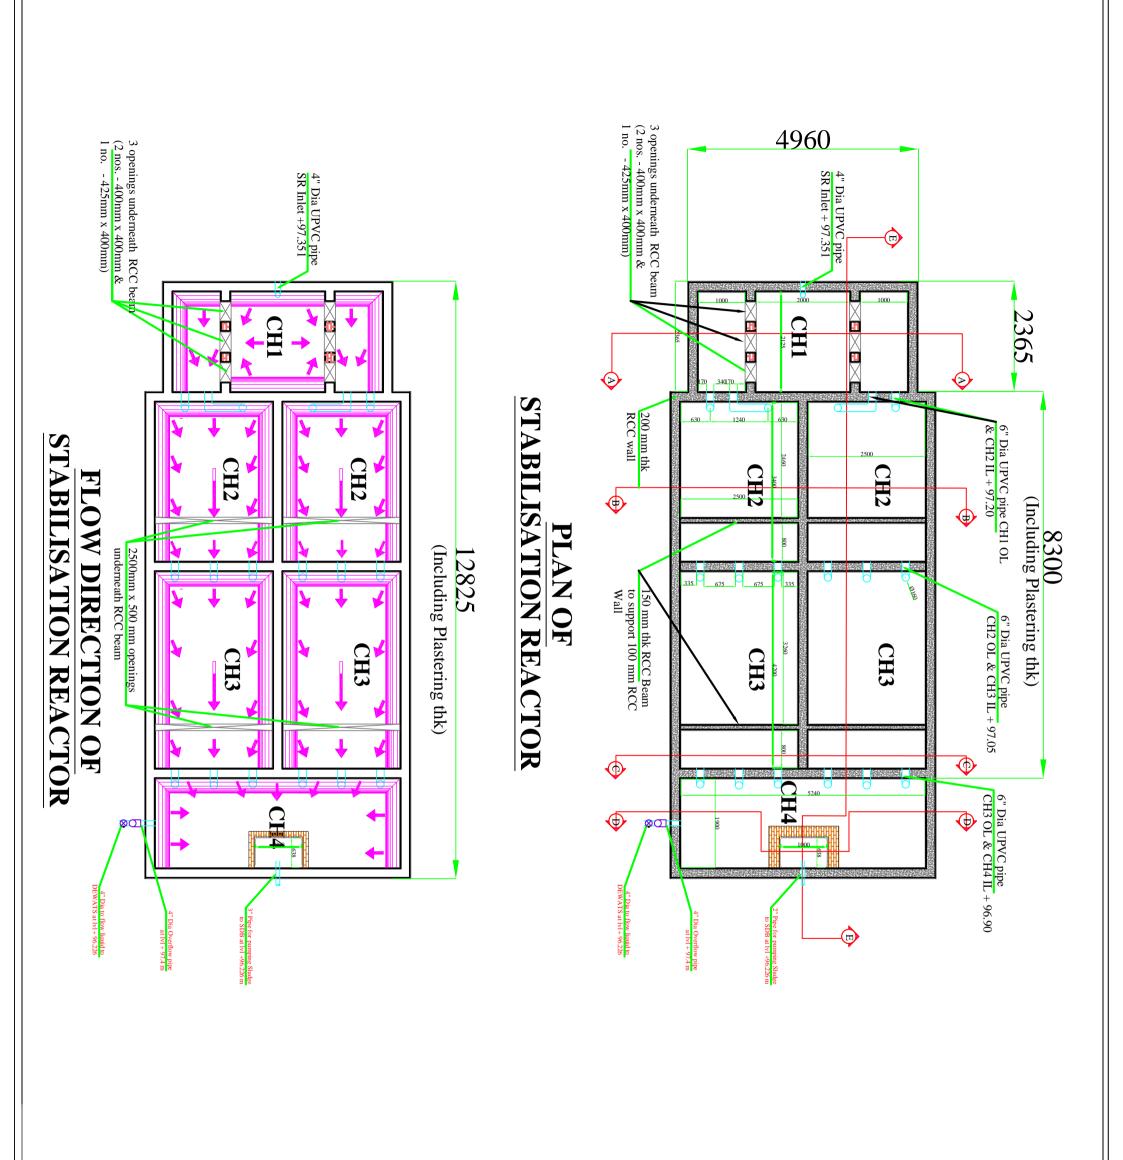

- 1. All dimensions are in 'mm' unless mentioned otherwise.
  2. All dimensions are checked and co-related with the arthectural drawings and any discrepancy or omission shall be brought to the notice.
  3. This is the property of BORDA/CDD & is not to be capited or produced anywhere without their permission.
  4. EGL = Existing Ground Level +96.5
  5. Road Ivi = +97.351
  6. Grade of concrete proposed (M15, M20 M25). It is recommended to use Sulphate Resistance Cement (SRC).
- Cement (SRC).

  7. R' indicates Register:
  SC' indicates Sachilization Reactor
  SC' indicates Stabilization Reactor
  SC' indicates Stabilization Reactor
  SDB' indicates Shable drying Bed
  PDB' indicates Shable of Piper Bed
  Trindicates Shable of Piper Bed
  ST' indicates Anaerobic Filter
  PGF indicates Phanted Gravel Filter
  PGF indicates Polashing Pond
  O'Ri indicates Operator Room
  G'Ri indicates Operator Room
  SSY' Shadge Storage House
  8. Use UPV C pipes (25-4mm, 55mm, 110mm & 150 mm dia (1", 2", 4" & 6")) which can withs
  pressure of 6kg/cm².
- pressure of okgorn.

  9. Bench Mark As per the layout plan provided

  10. For percolate treatment structures inner plastering (walls and base) of 20mm thick is considered.

ATE		
REMARKS	REVISIONS	
SIGNATURE		
		REVISIONS REMARKS

## STABILIZATION REACTOR:-

Plan of SR and Flow Direction of SR

BAGRU/FSTP/CD/SR-01

PROJECT NAME

## **BAGRU FSTP**

CLIENTS CONSULTANT:

Consortium for DEWATS
Uissemination

NIUA, DLB and Nagar Palika Bagru

Survey No.205,

Opp. Beedi Workers Colony,

CHECKED BY Praveen. N DATE Kommaghatta Road, Bandemath BANGALORE - 560 060 KARNATAKA. APPROVED BY Praveen. N DATE

Ritesh Kumar Suman

DRAWN BY


SCALE: NTS

SHEET 04 OF 27 SHEETS


22/02/2018 DATE

22/02/2018

22/02/2018

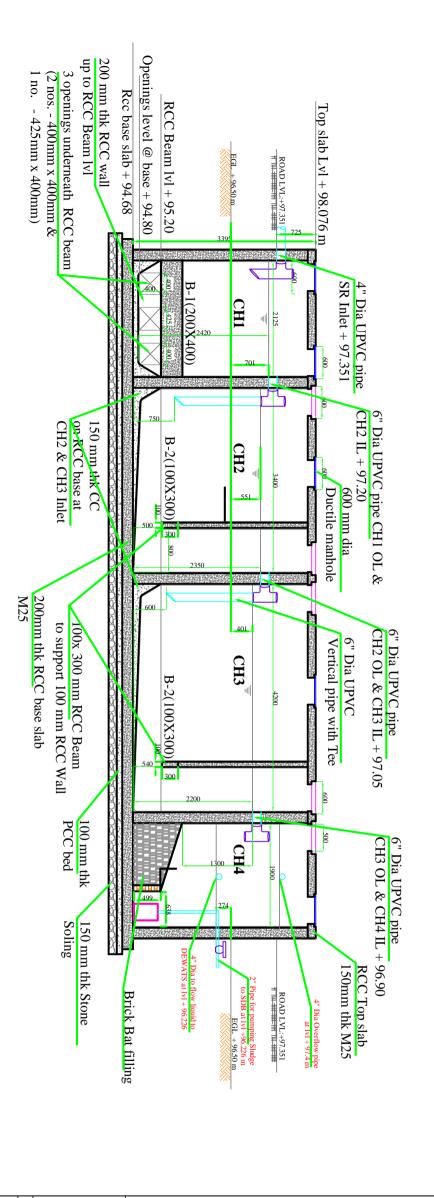

## **LONGITUDINAL SECTION @ E-E**

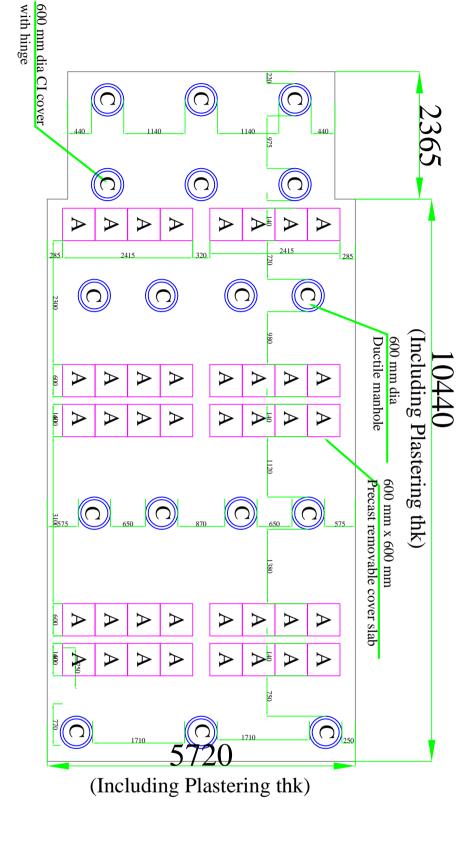

## **Manhole Covers Details**

Type A - 40 nos. (600 mm x 600 mm size) Type C -17 nos. (600mm dia CI covers)

MANHOLE LAYOUT PLAN

## NOTES

- All dimensions are in 'mm' unless mentioned otherwise.
   All dimensions are checked and co-related with the architectural drawings and any discrepancy or omission shall be brought to the notice.
   This is the property of BORDA/CDD & is not to be copied or produced anywhere without their permission.
   BGL = Existing Ground Level +96.5
   Road Ivl = +97.351
   Grade of concrete proposed (M15, M20 M25). It is recommended to use Sulph Compant (SRC).

ided to use Sulphate Resistance

- th Mark = As per the layout plan provided percolate treatment structures inner plastering (walls and base) of 20mm thick is idered.

Ju.		
	REVISIONS	
	REMARKS	SIGNATURE
TE		

## STABILIZATION REACTOR:-

Longitudinal Section @E-E and Manhole Layout Plan

## PROJECT NAME

BAGRU/FSTP/CD/SR-02

## **BAGRU FSTP**

NIUA, DLB and Nagar Palika Bagru

## Consortium for DEWATS Unseemination Saction

CLIENTS CONSULTANT: Survey No.205, Opp. Beedi Workers Colony,

DATE	Praveen. N	CHECKED BY	Kommaghatta R BANGALORE - KARNATAKA.
DATE	Praveen. N	APPROVED BY	Kommaghatta Road, Bandemath BANGALORE - 560 060 KARNATAKA.

Ritesh Kumar Suman

DRAWN BY

SCALE: NTS


SHEET 05 OF 27 SHEETS


22/02/2018


22/02/2018


22/02/2018


DATE

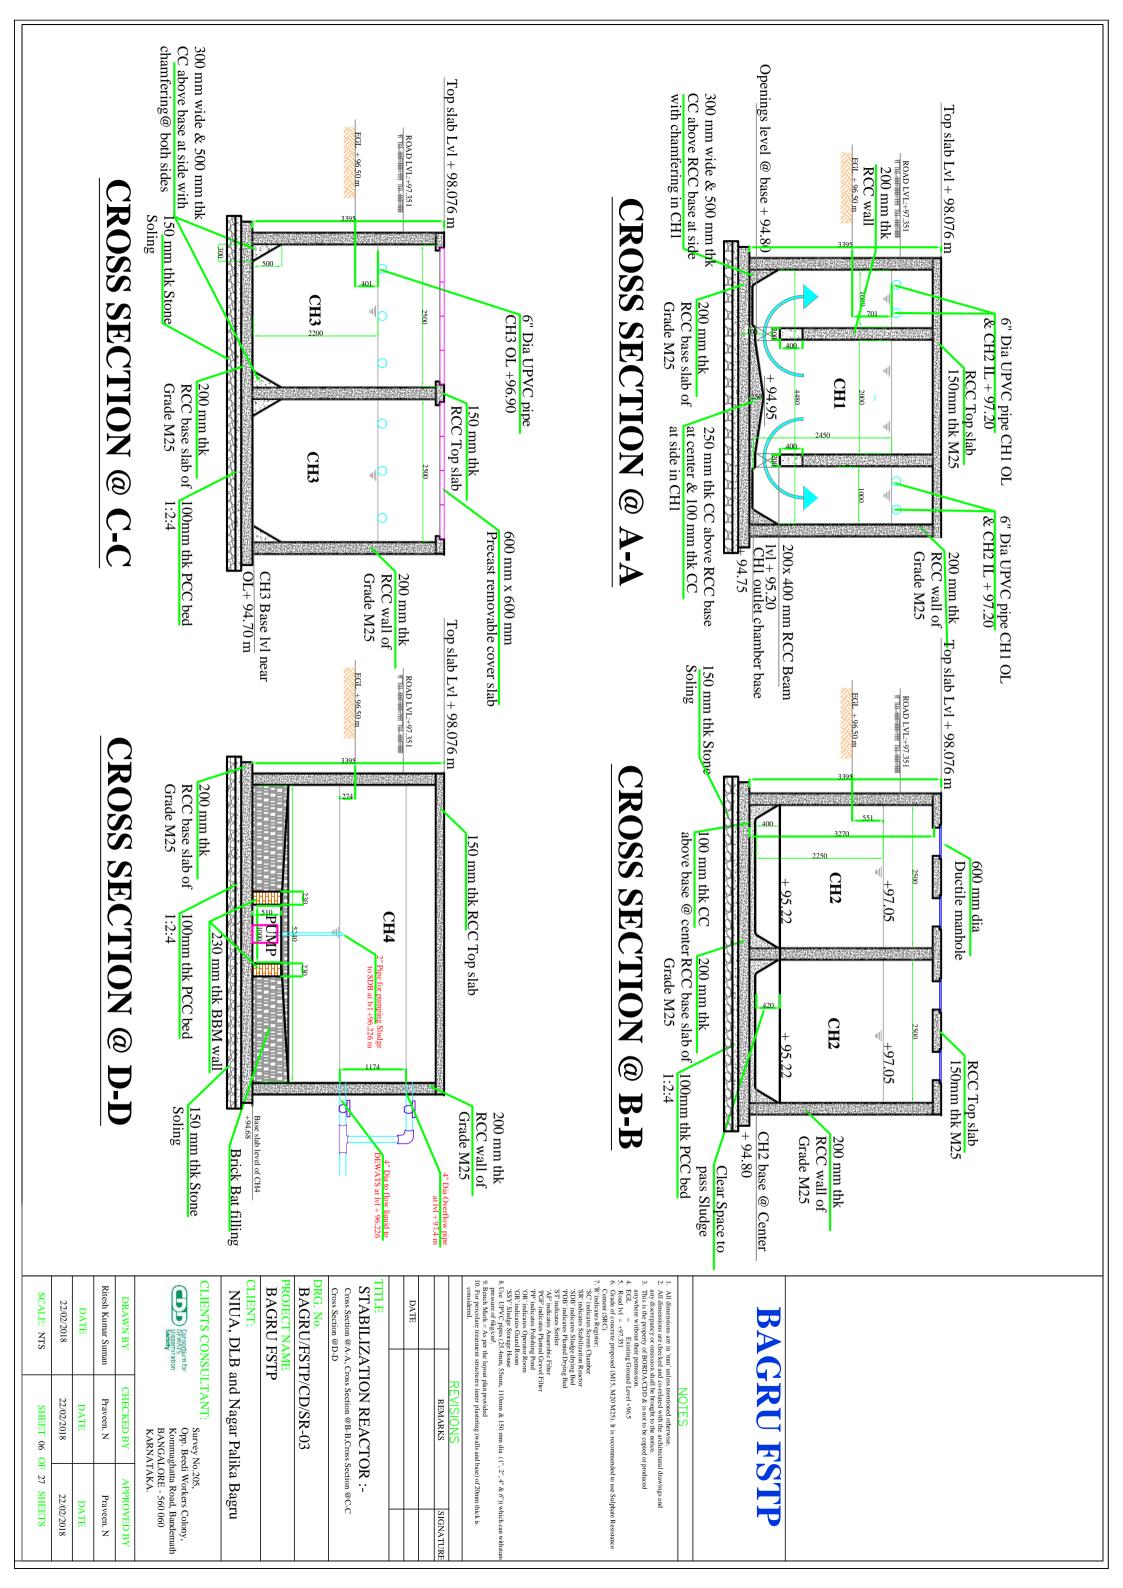


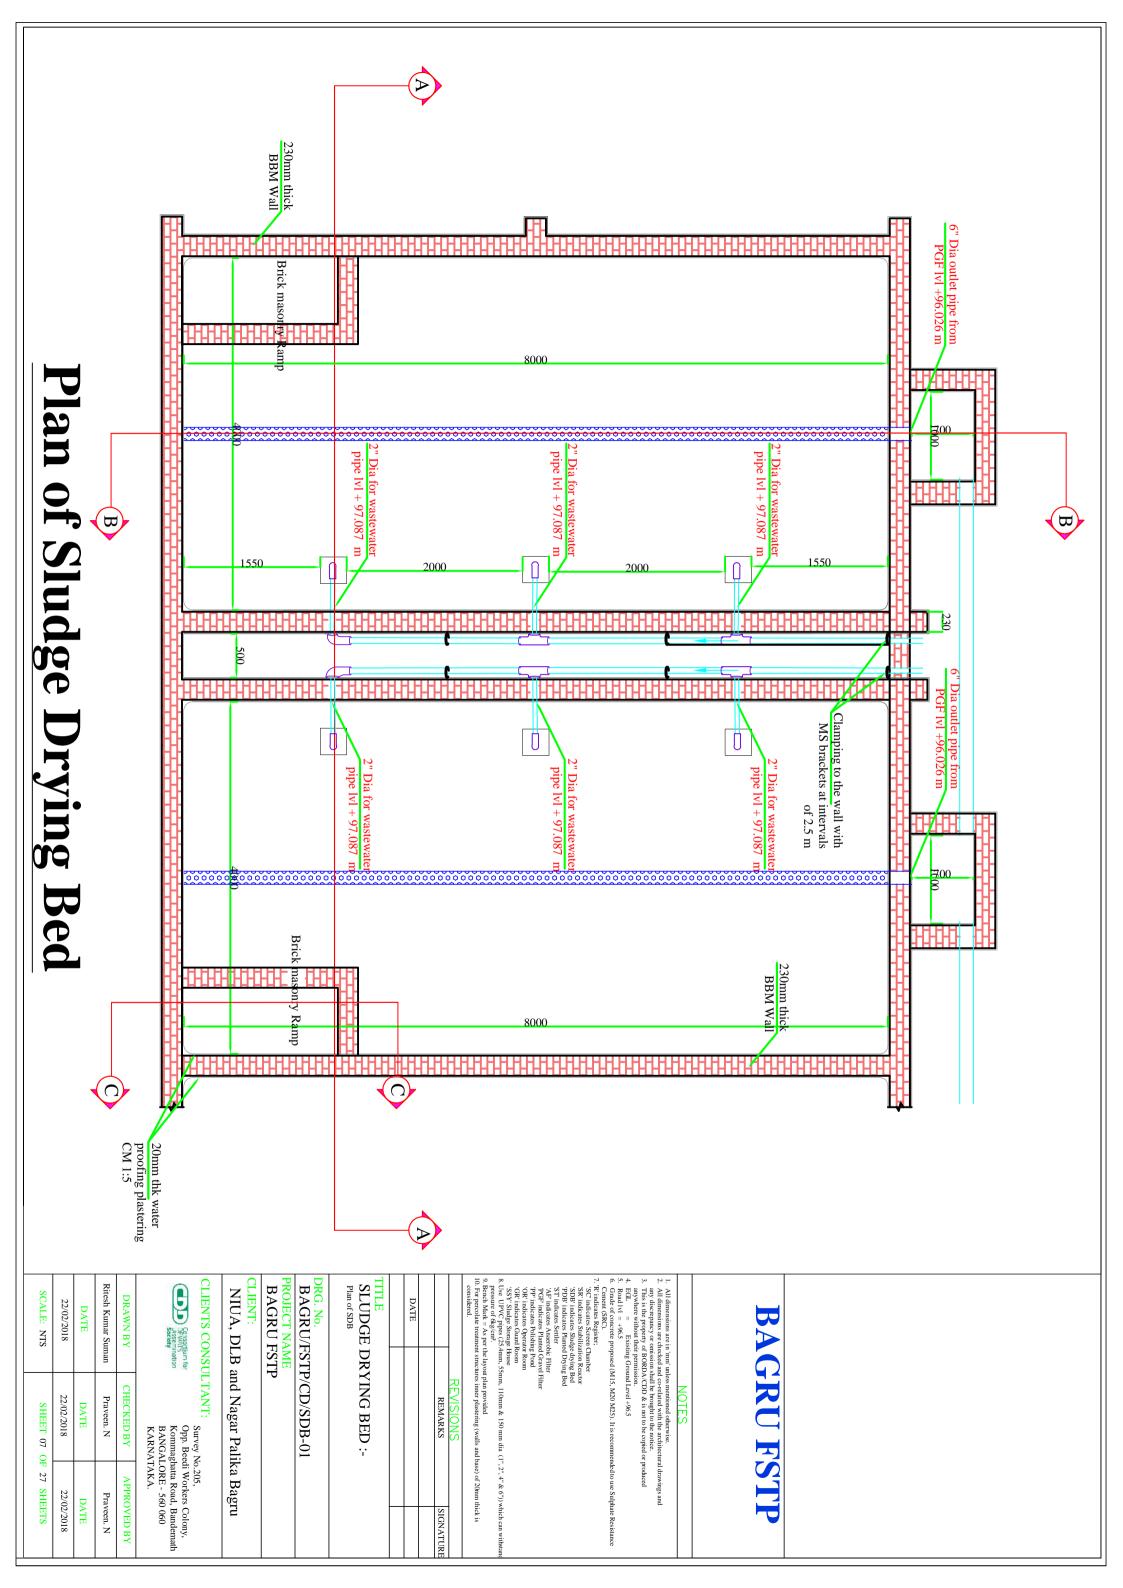

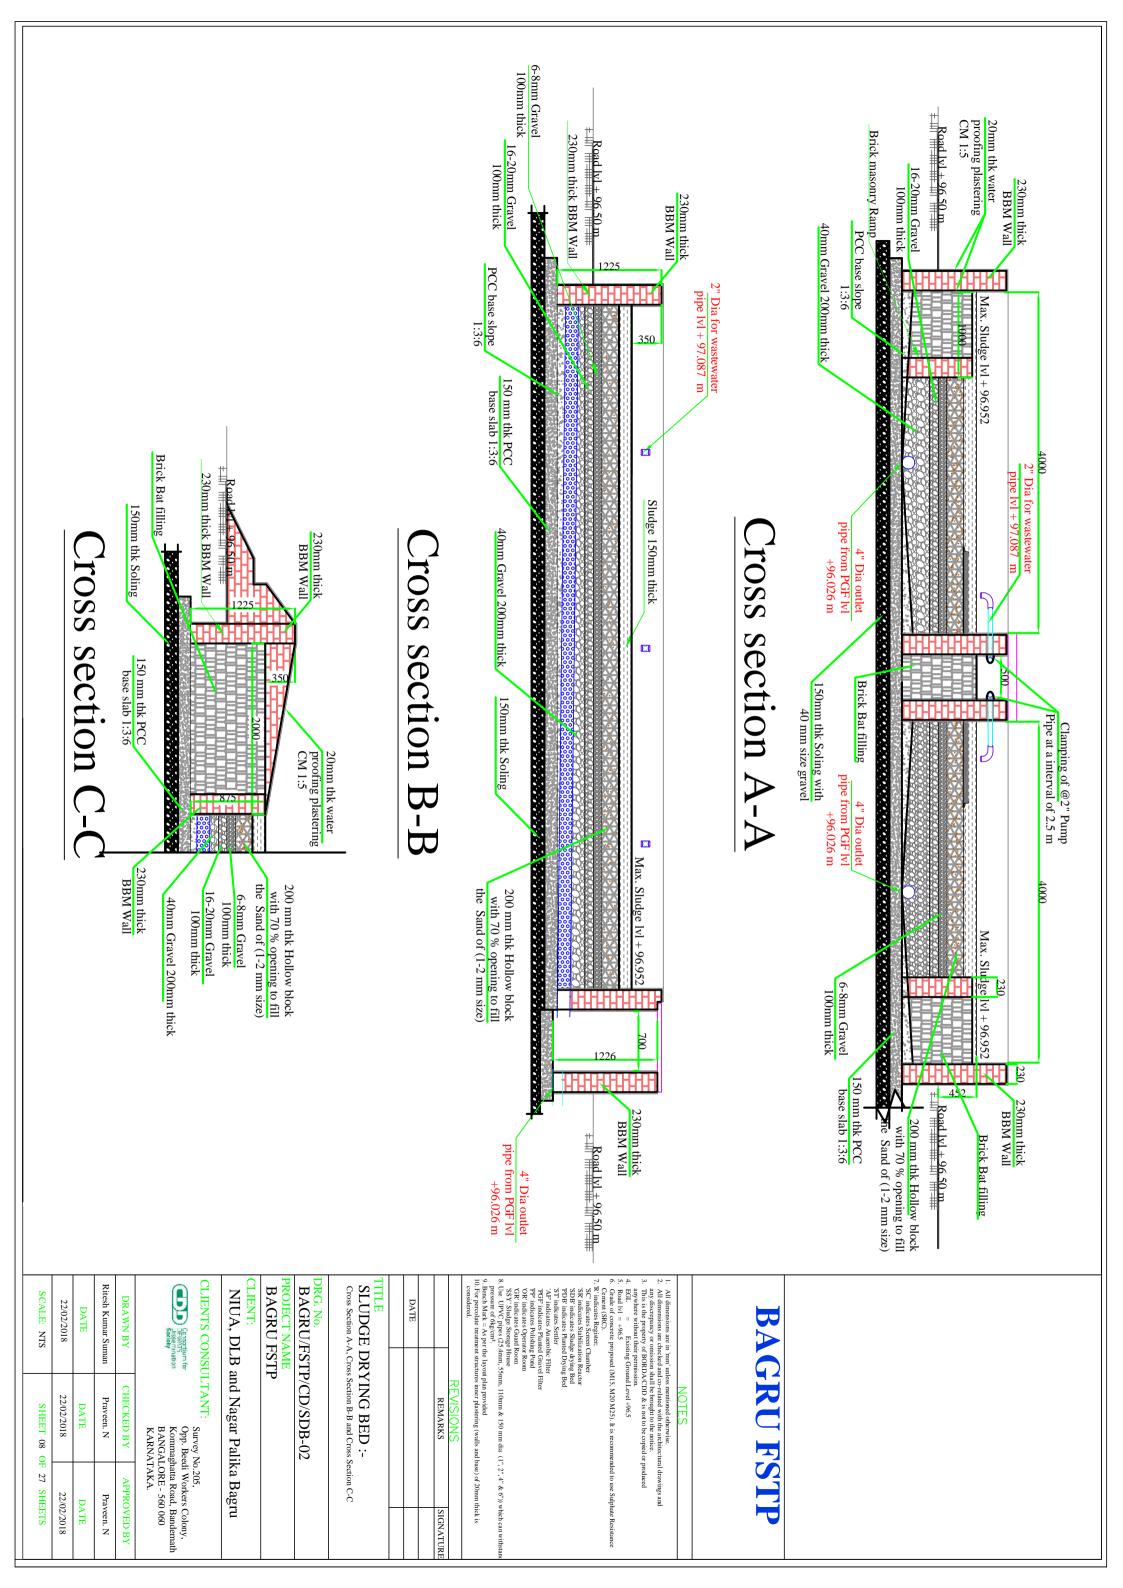

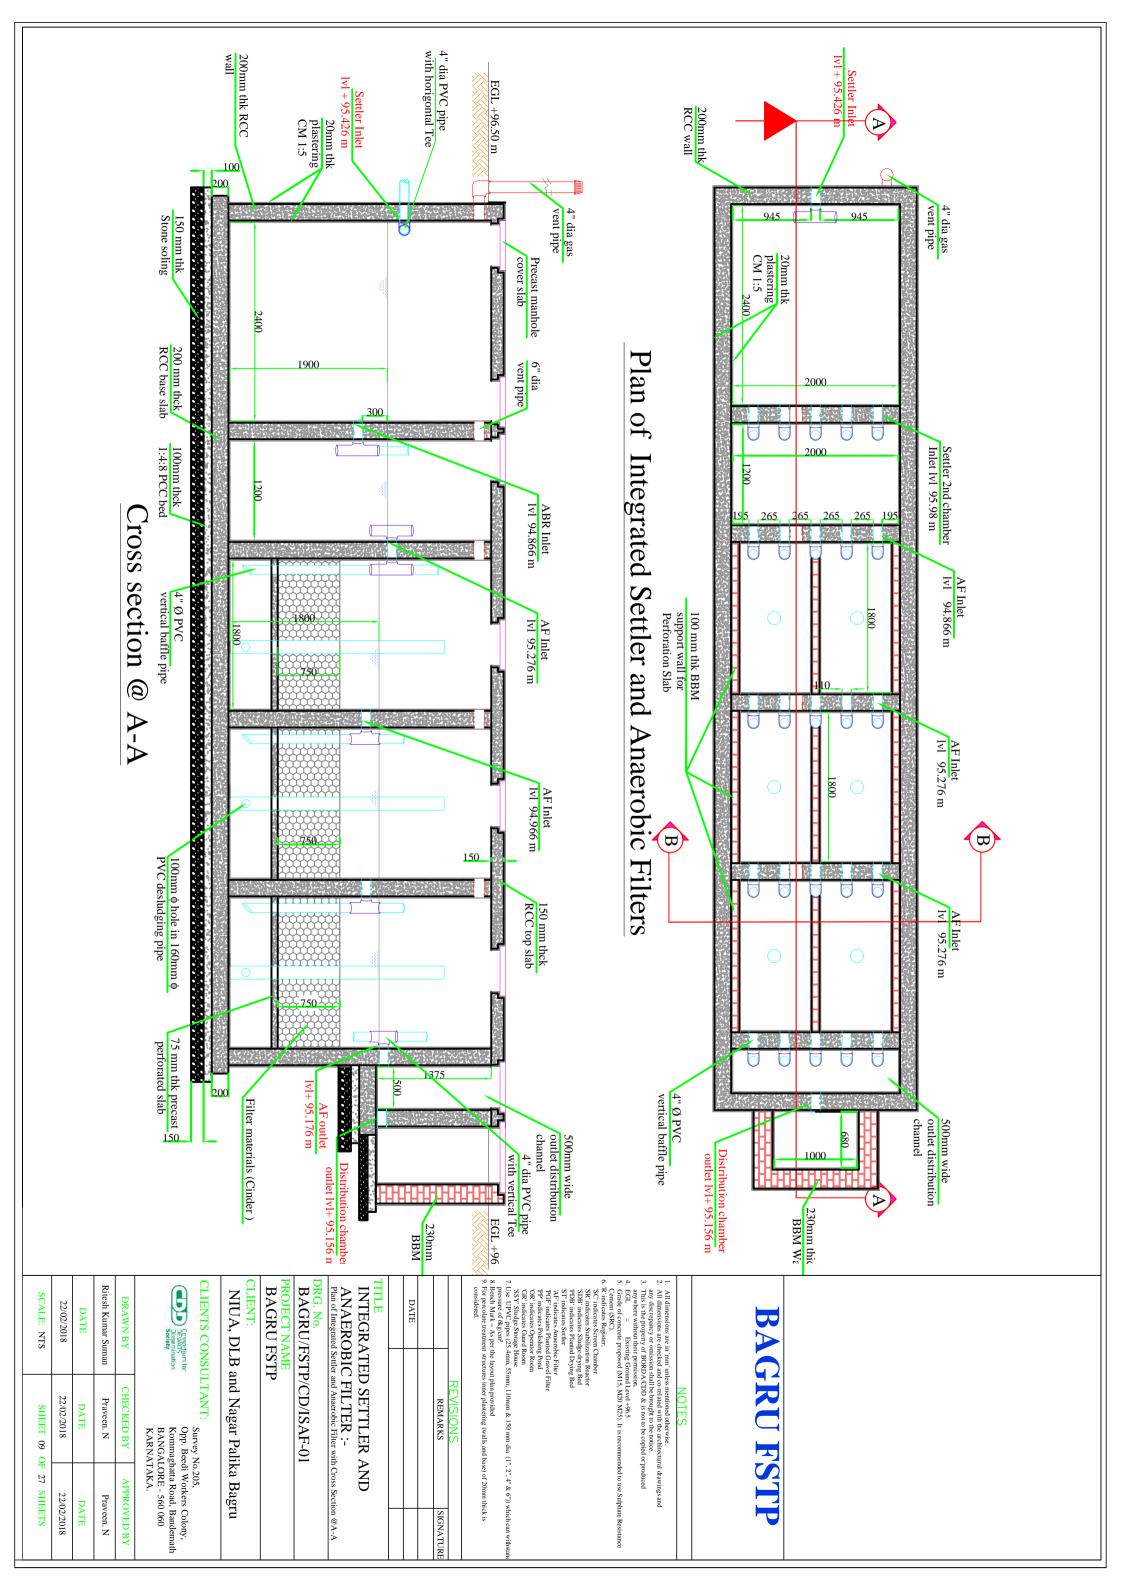

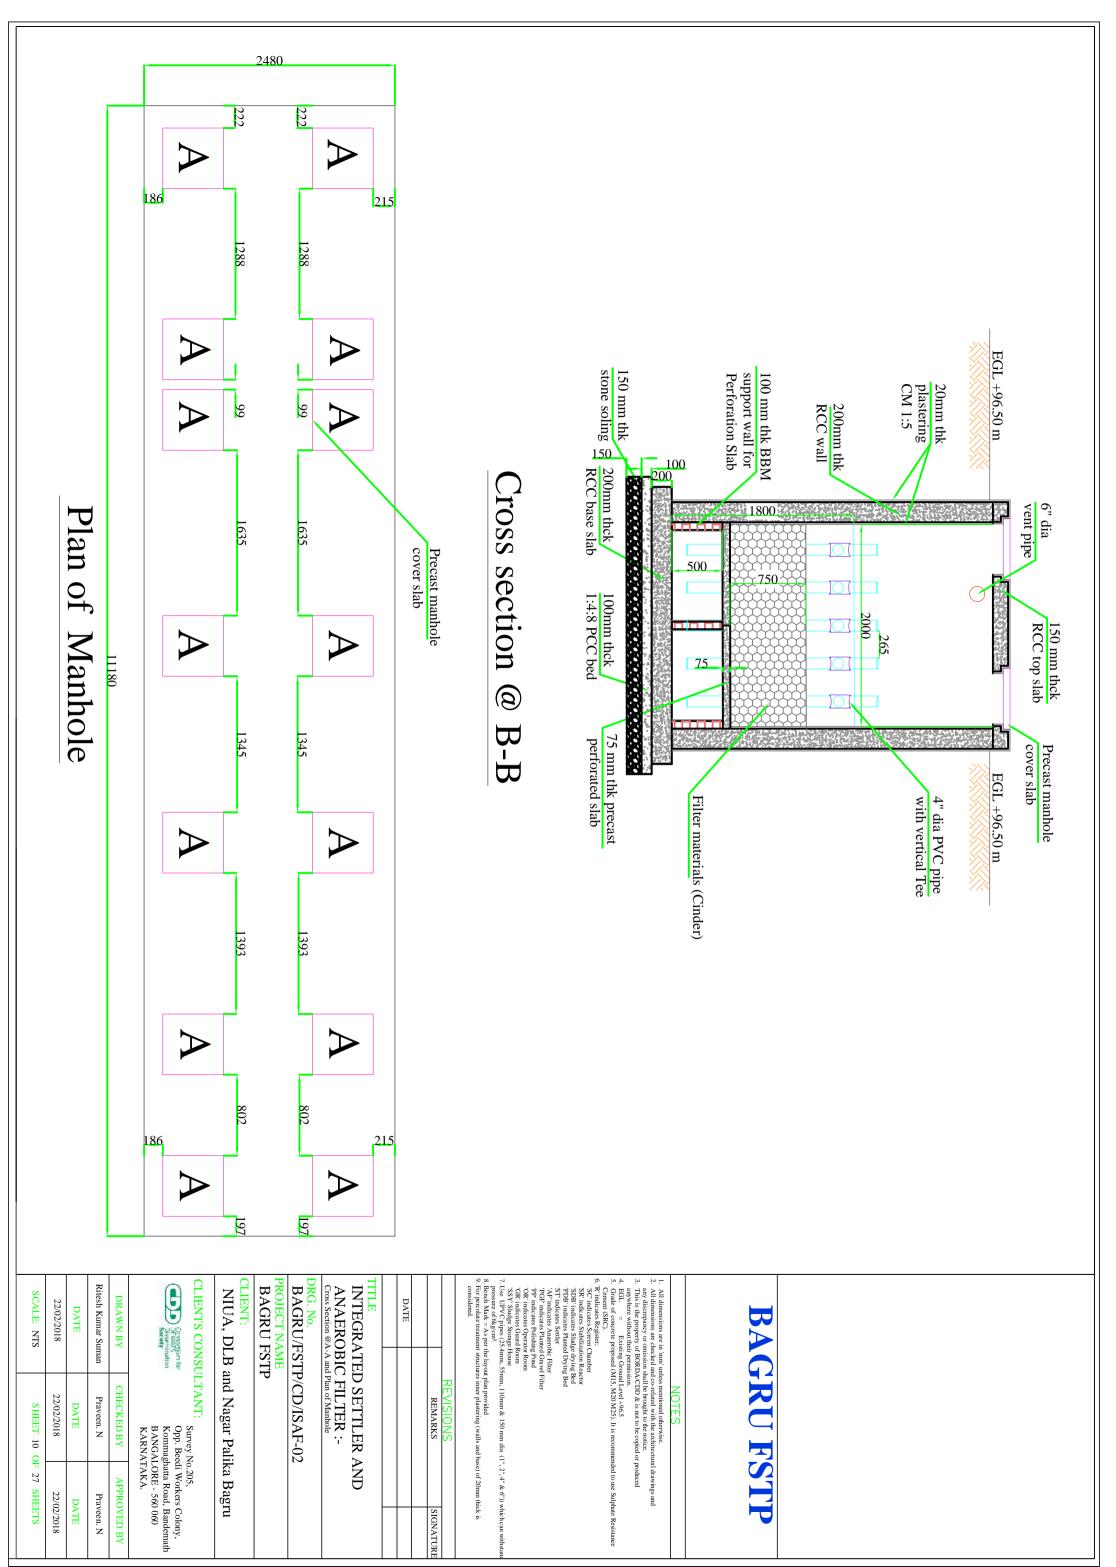


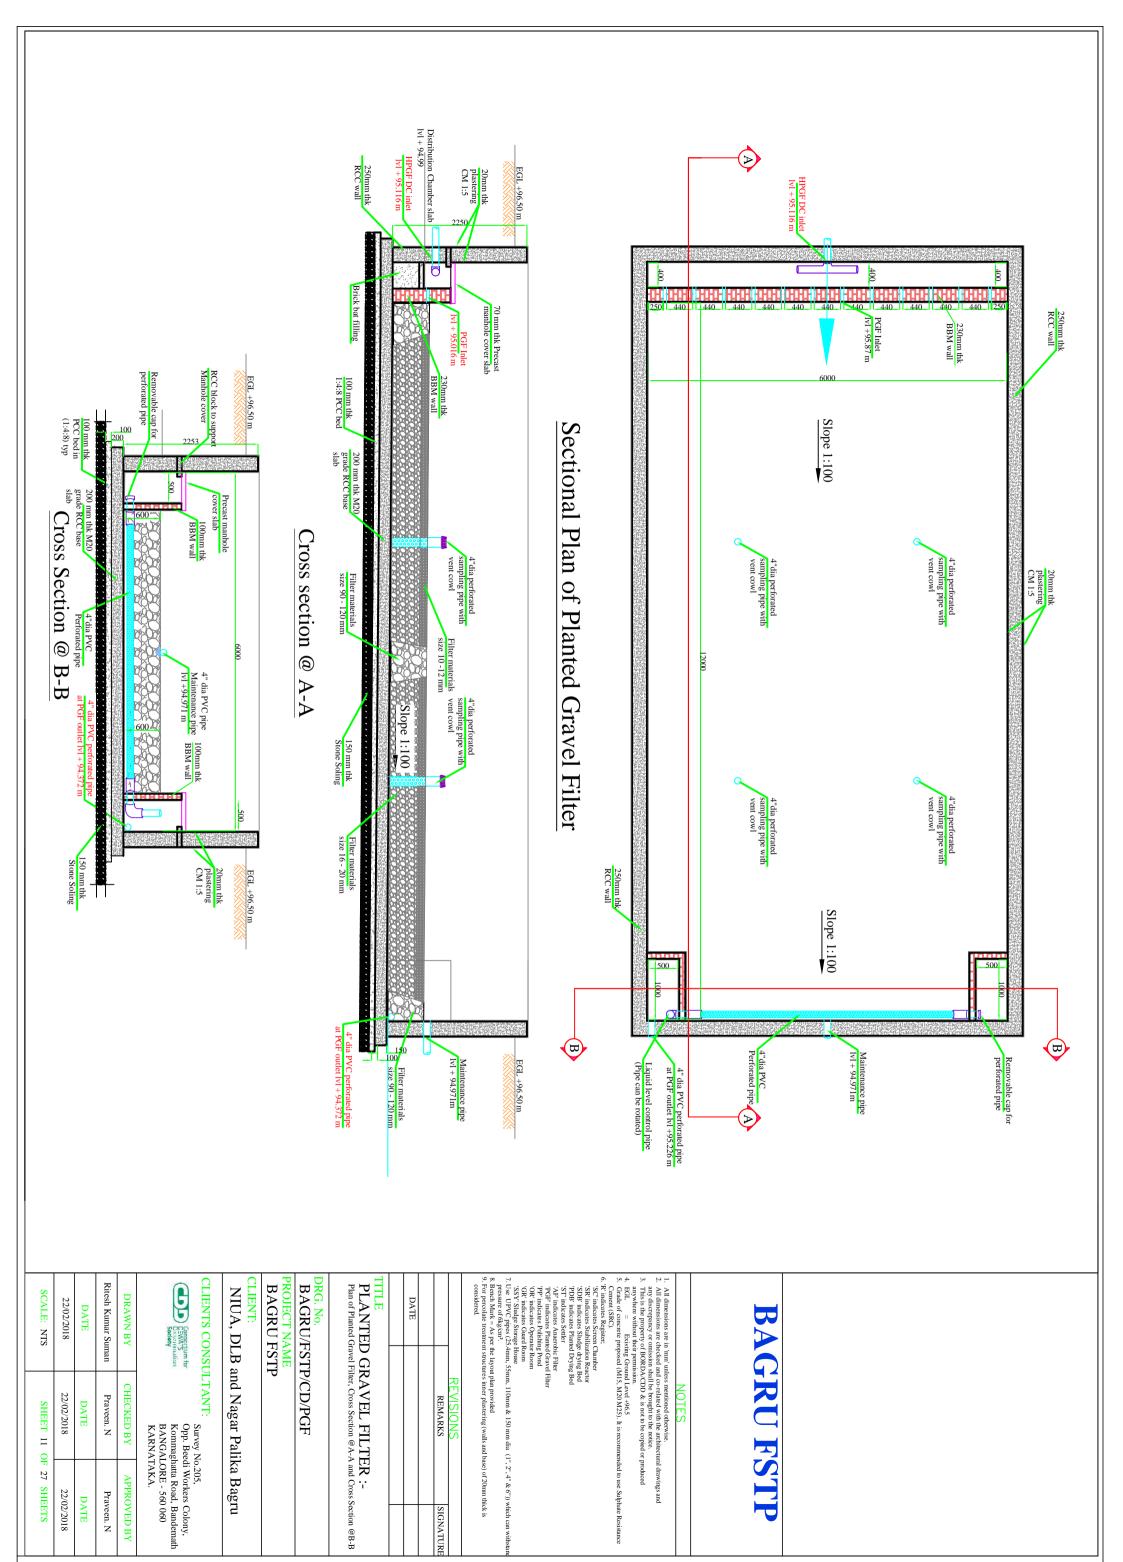



SIGNATURE


22/02/2018

Praveen. N DATE

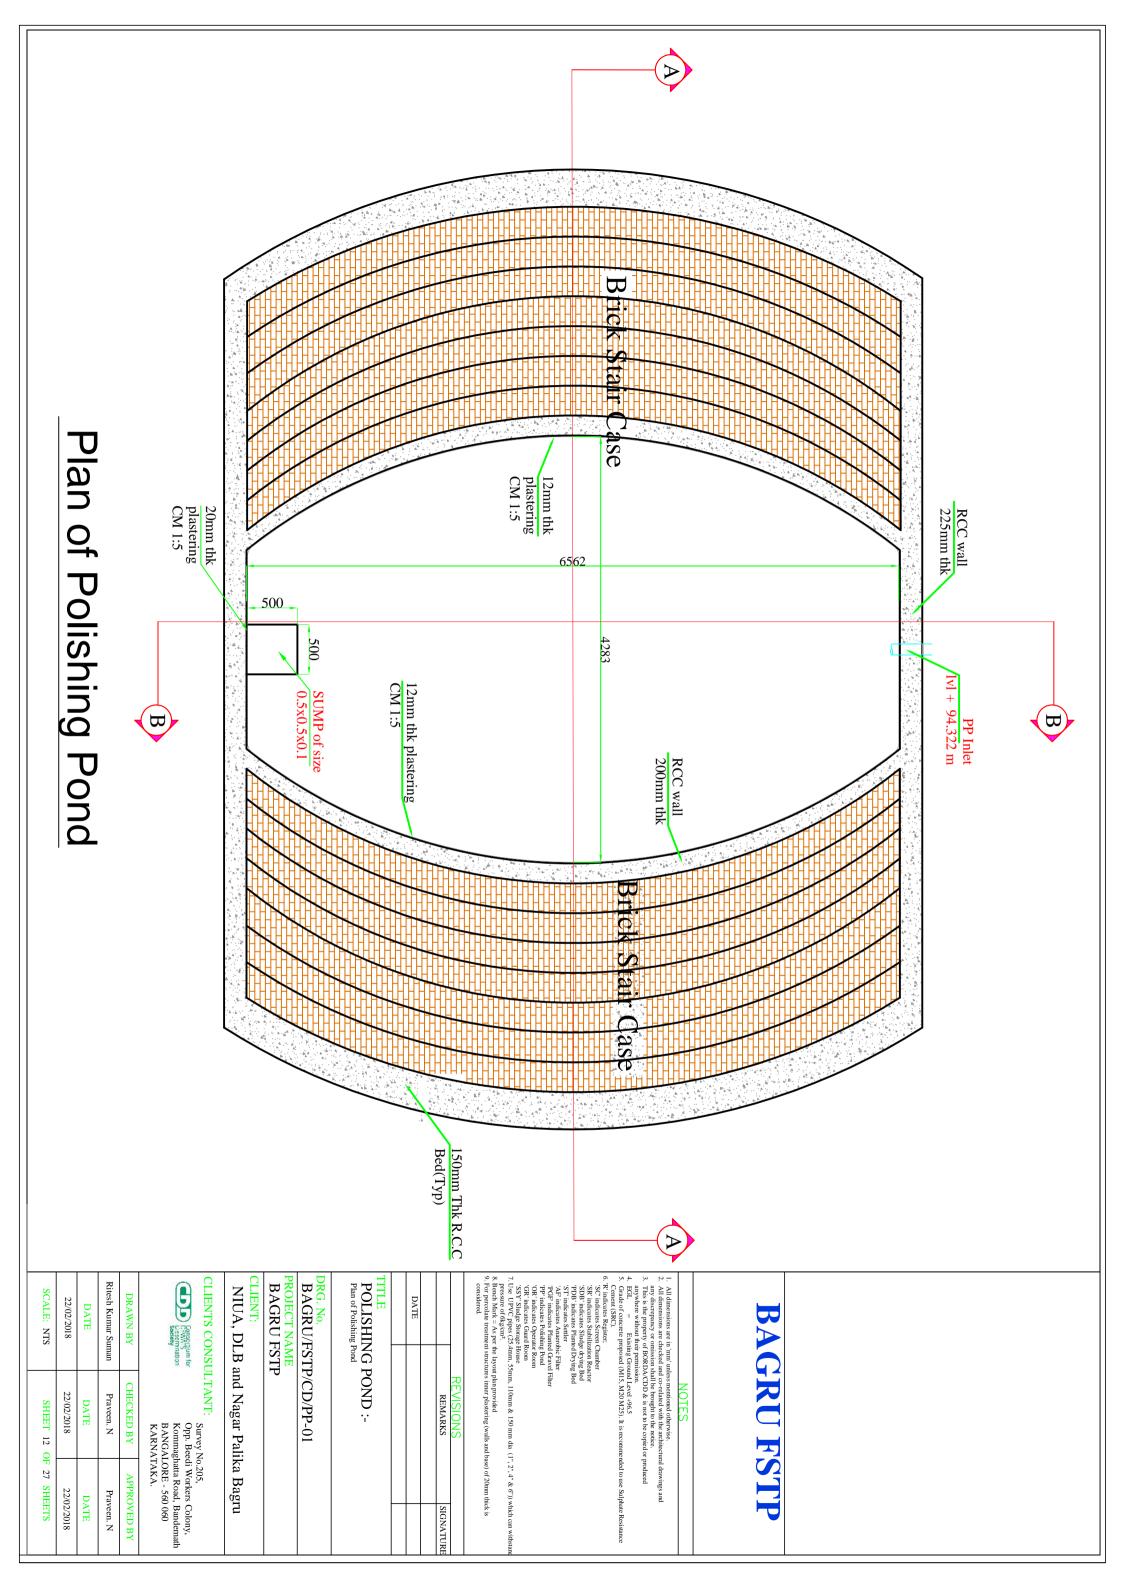


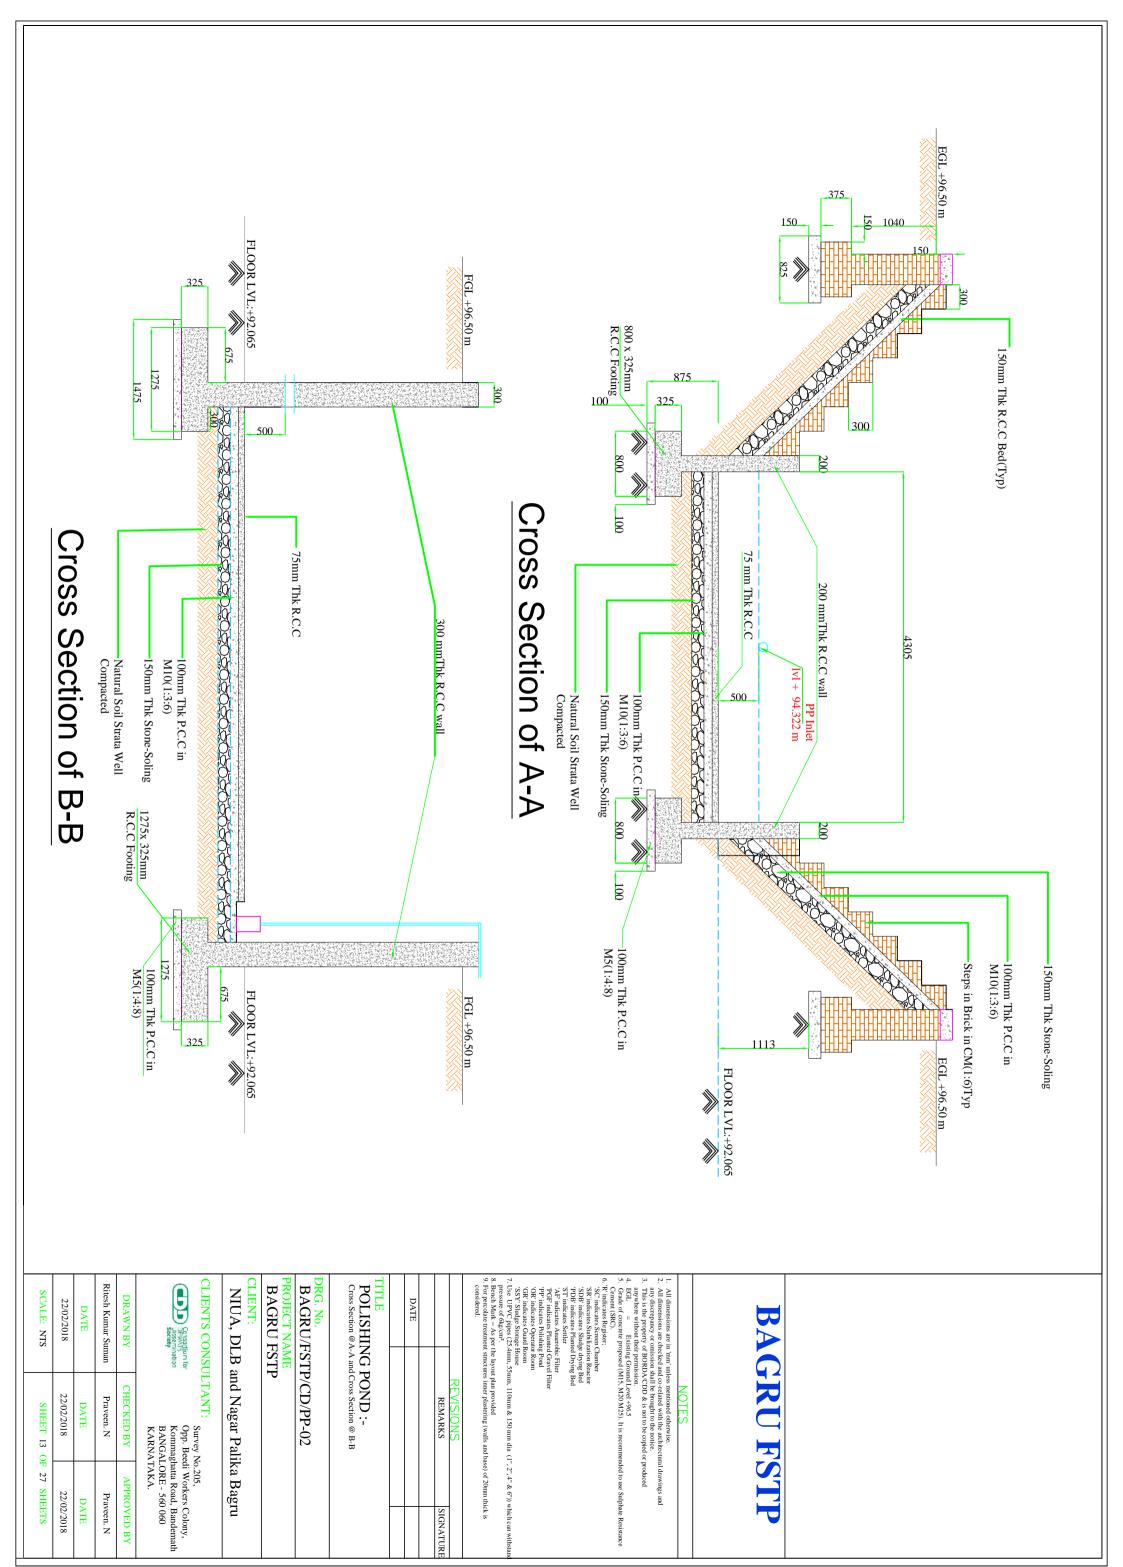

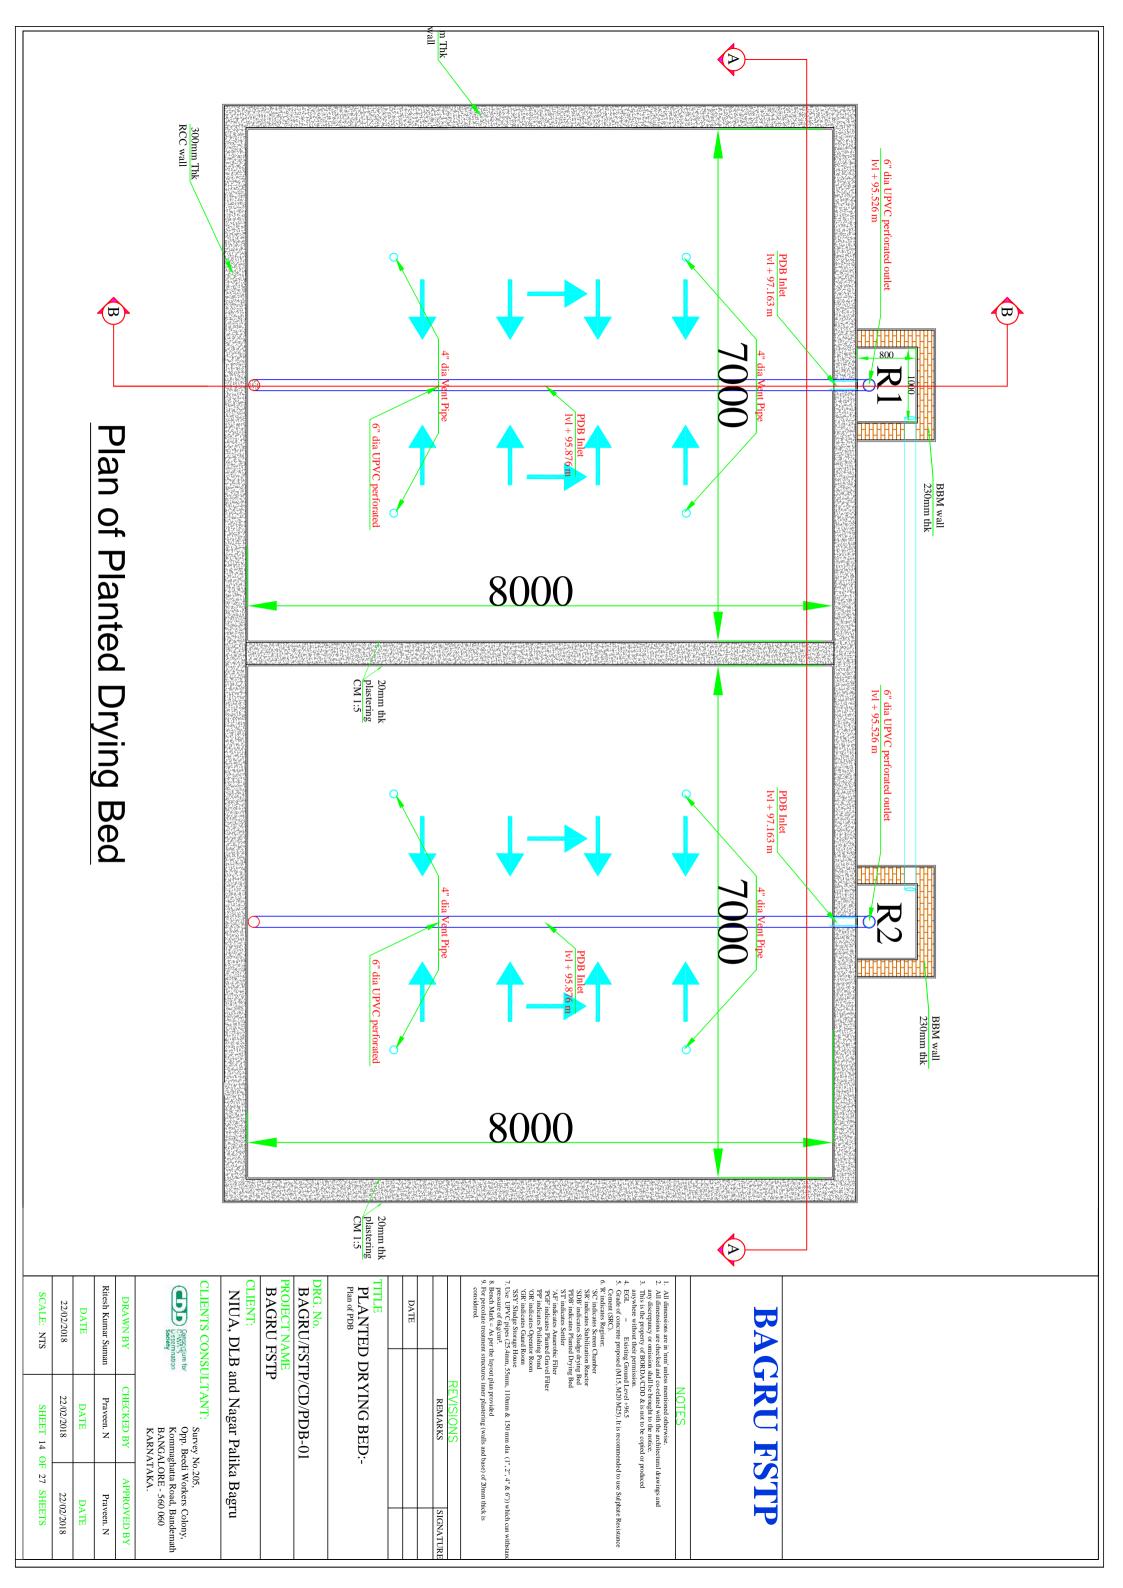

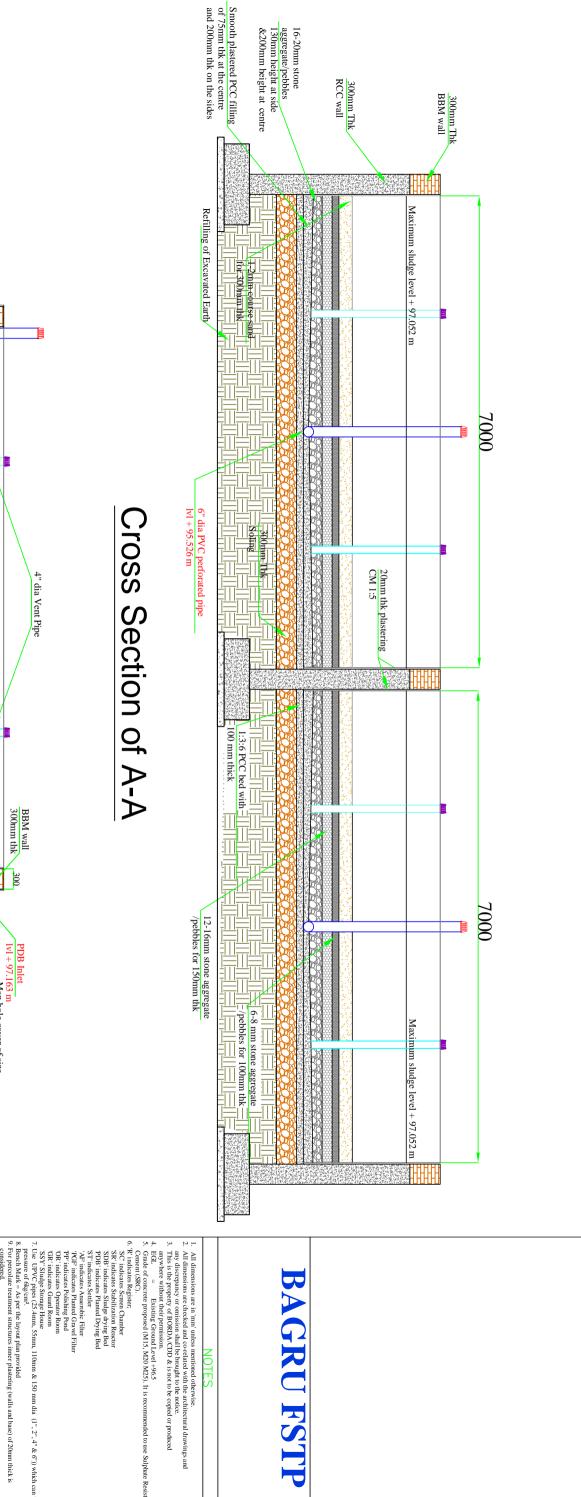

## Cross Section of A-A

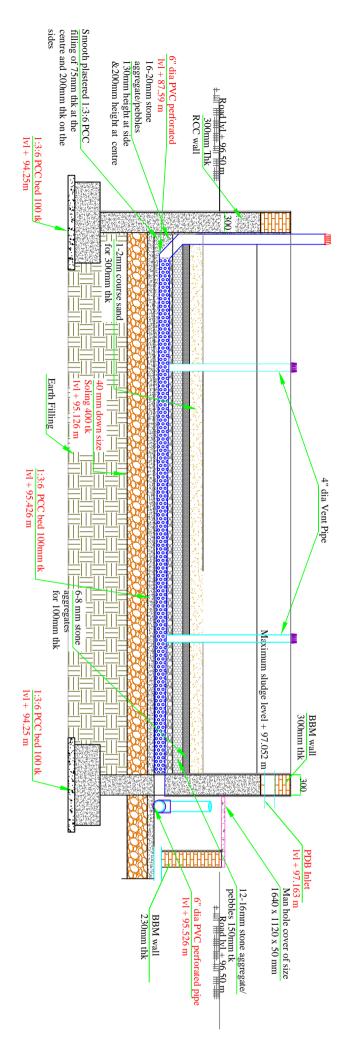

## Cross Section of B-B

## BAGRU FSTP

## NOTES

	DATE			
		REMARKS	REVISIONS	
		SIGNATURE		

## PLANTED DRYING BED:-Cross Section @A-A and Cross Section @B-B

## BAGRU/FSTP/CD/PDB-02

PROJECT NAME BAGRU FSTP

## NIUA, DLB and Nagar Palika Bagru

CLIENTS CONSULTANT:

Consortium to DEWATS Dissemination Society

Survey No.205,

CHECKED BY	KARNATAKA.	BANGAI	Kommag	Opp. Bee
APPROVED BY	ΓΑΚΑ.	BANGALORE - 560 060	Kommaghatta Road, Bandemath	Opp. Beedi Workers Colony,


Dissemination Society	Kommaghatta R BANGALORE - KARNATAKA.	Kommaghatta Road, Bandemath BANGALORE - 560 060 KARNATAKA.
DRAWN BY	CHECKED BY	APPROVED BY
Ritesh Kumar Suman	Praveen. N	Praveen. N
DATE	DATE	DATE
31/10/2018	32/20/2018	22/02/2018


SCALE: NTS


SHEET 15 OF 27

SHEETS

22/02/2018 DATE

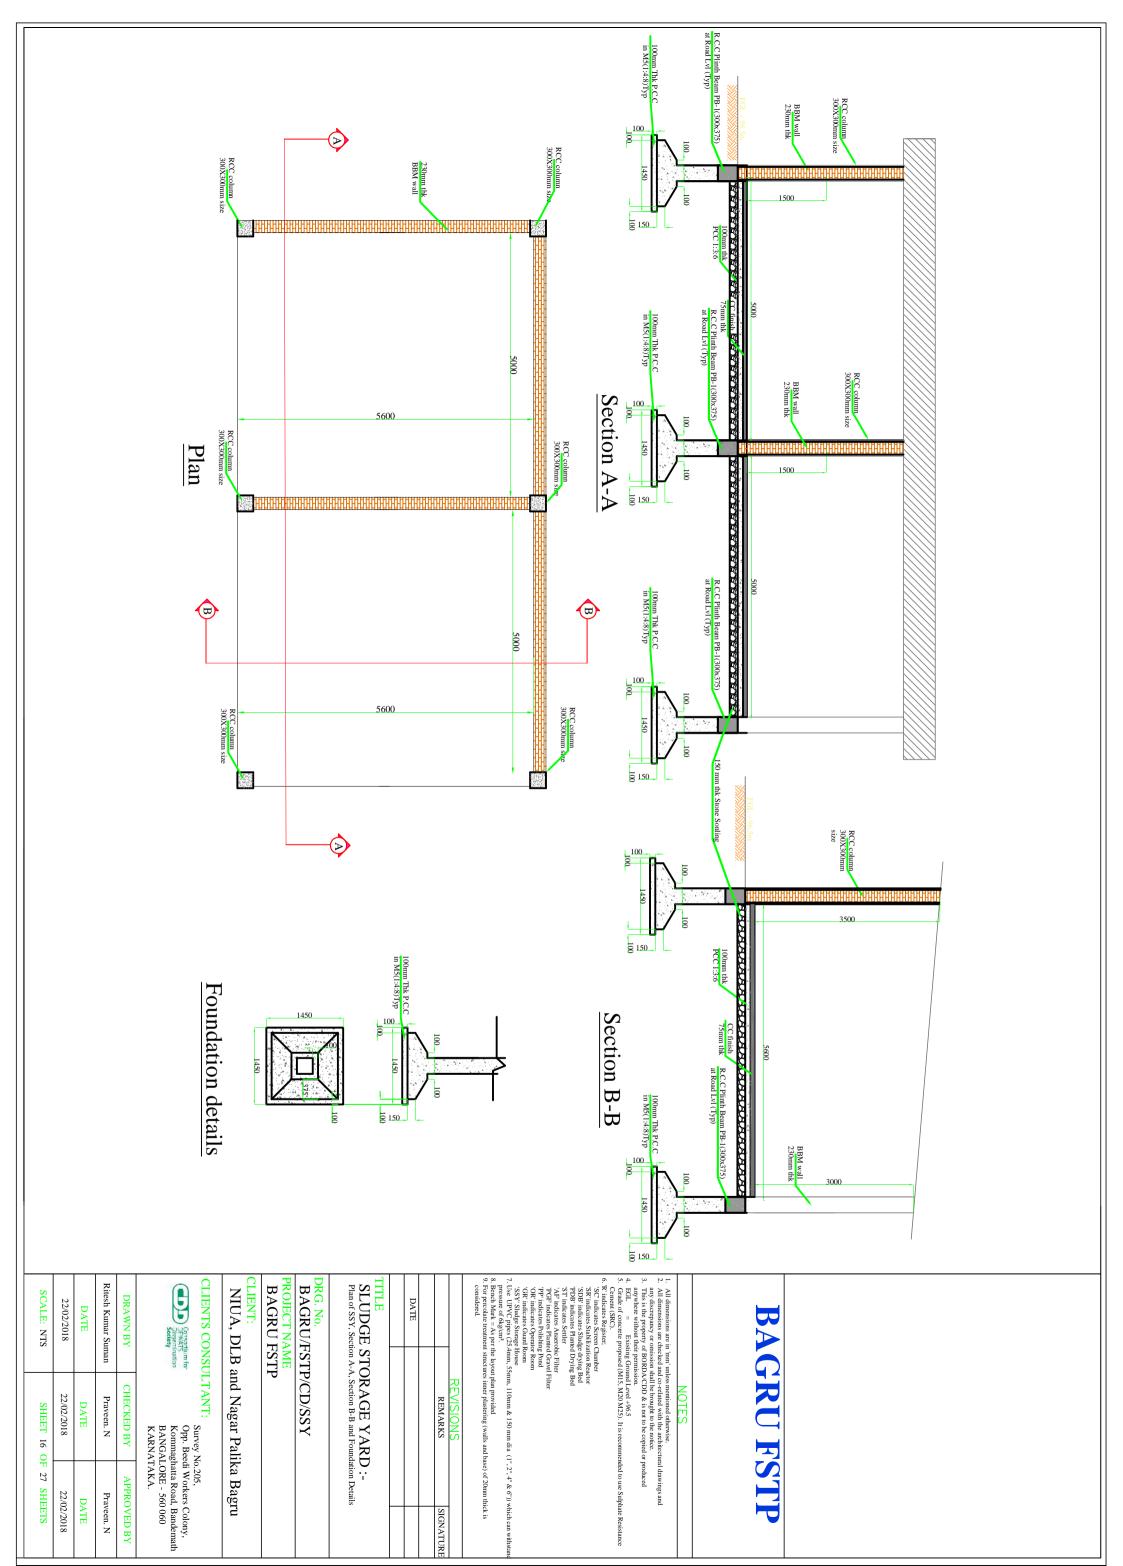


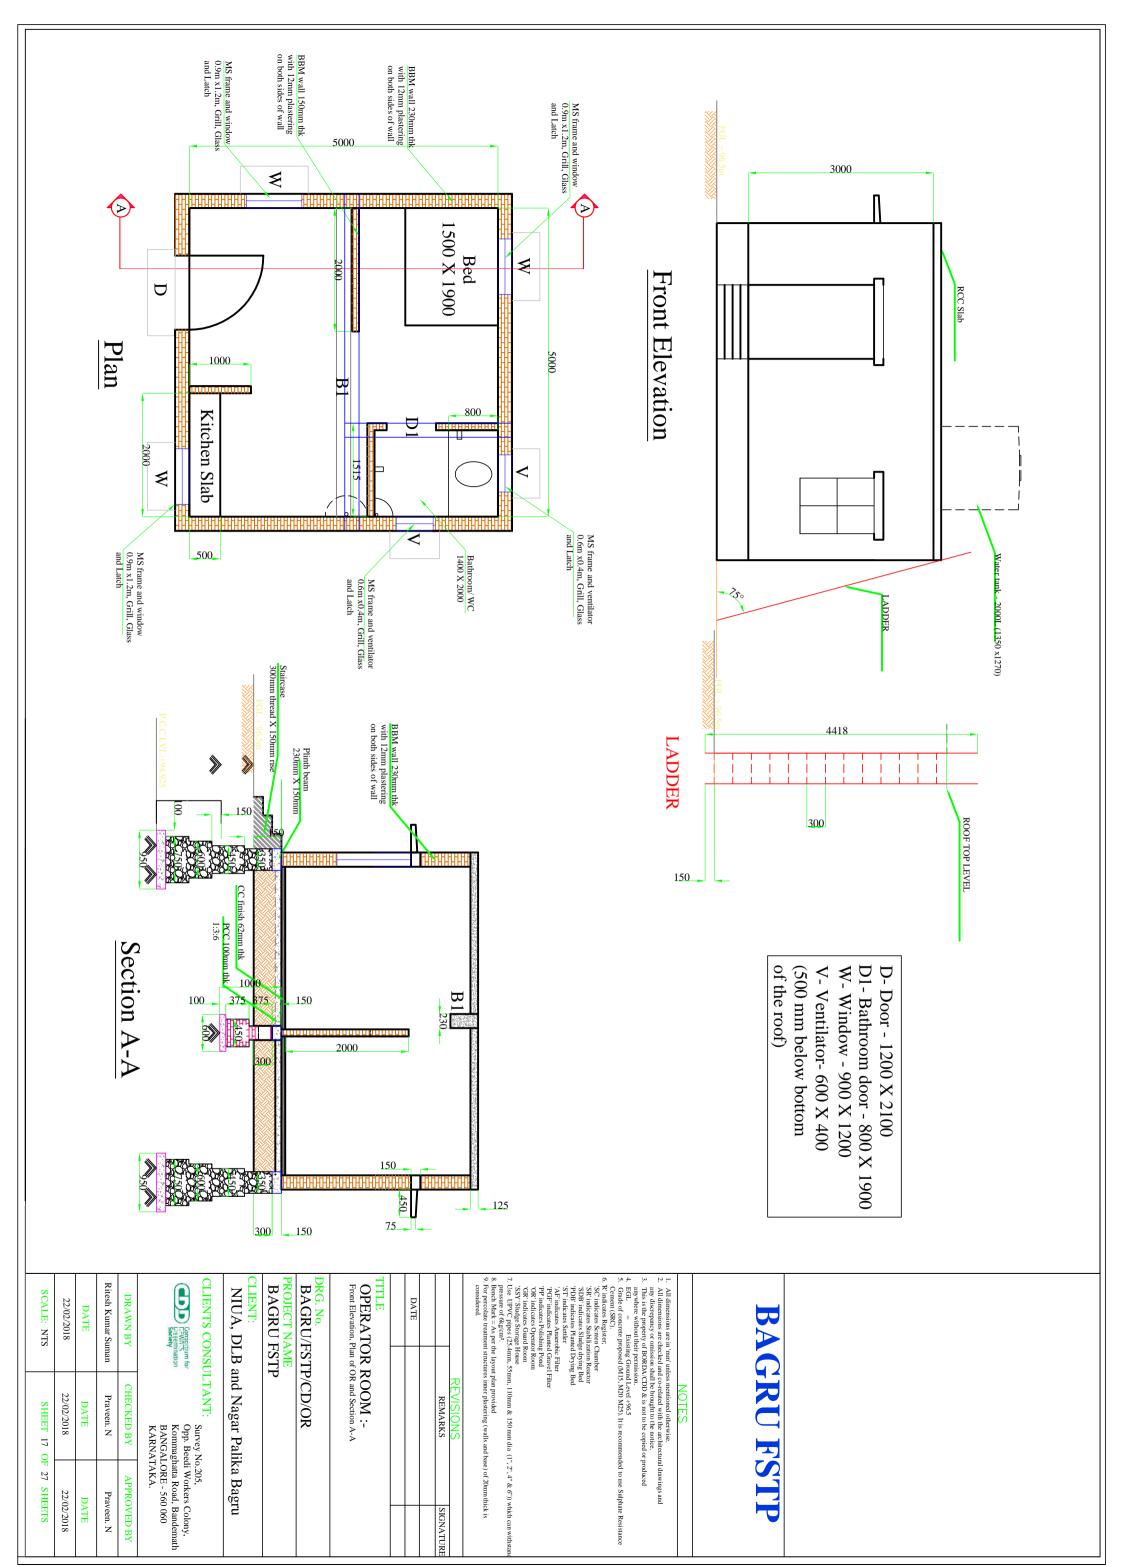

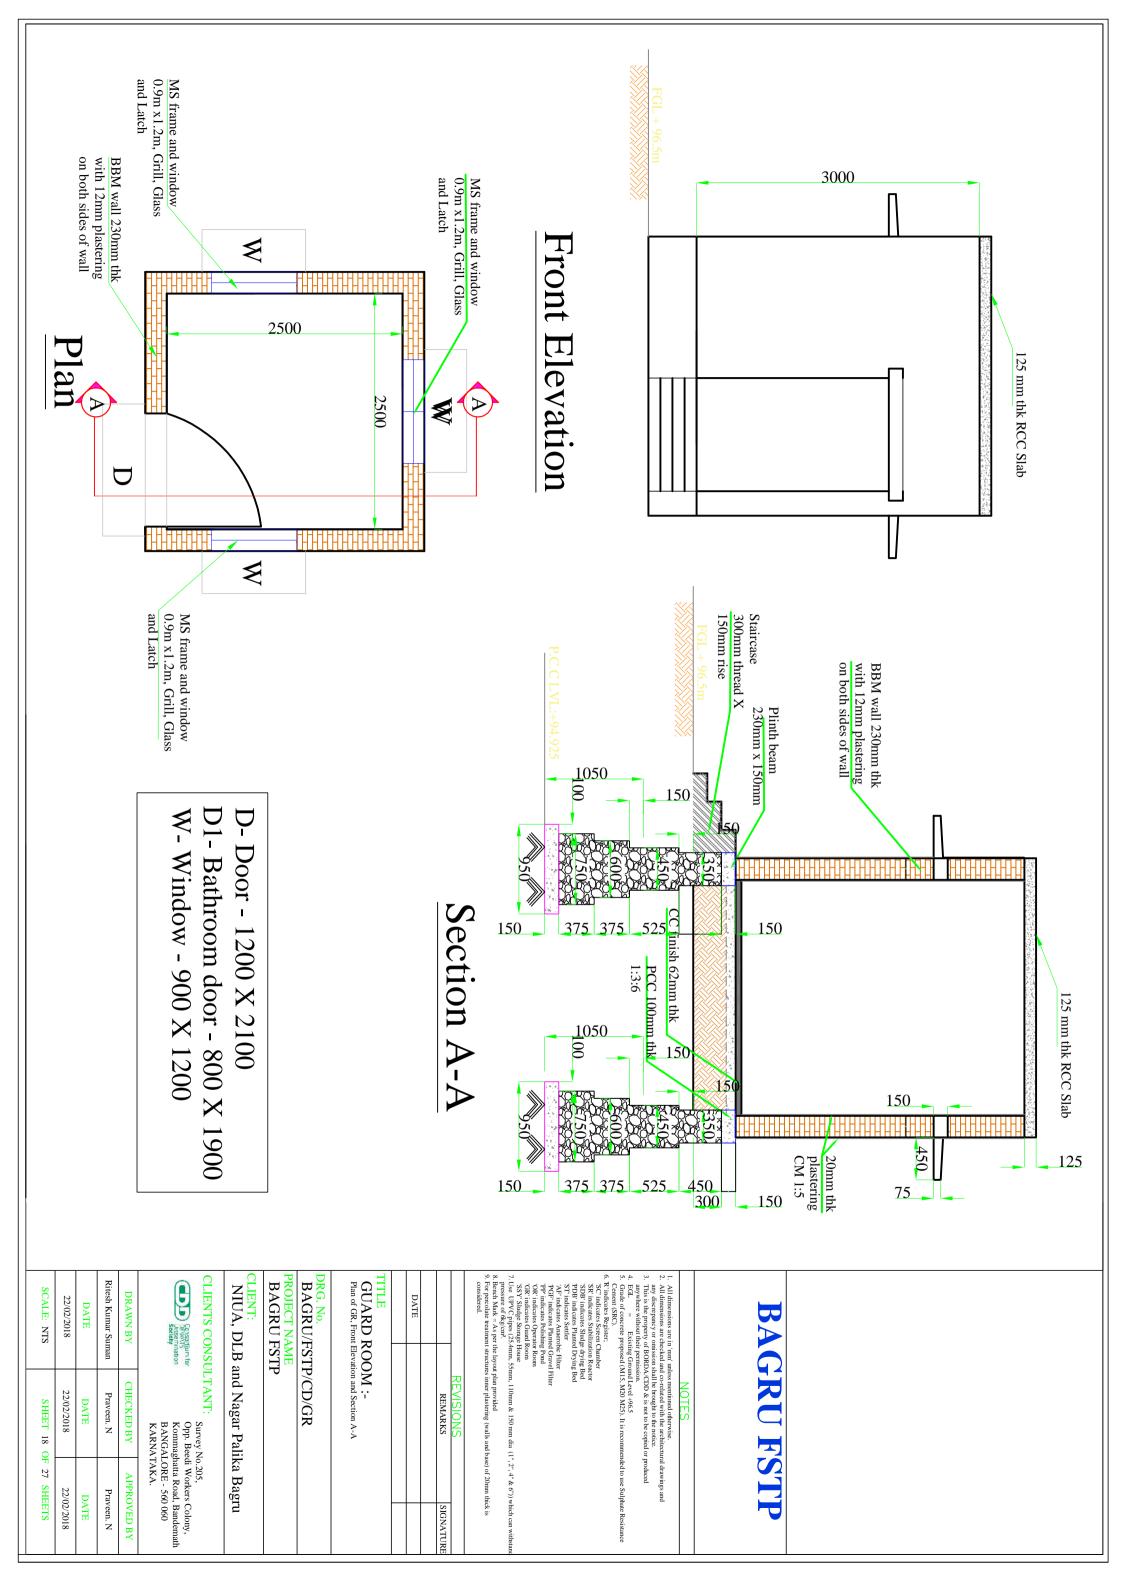

## PROPOSED CARRIAGE WAY

Black Top

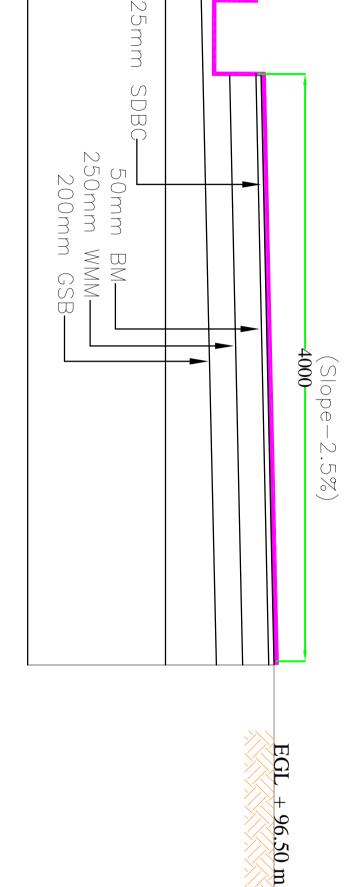

# TYPICAL CROSS SECTION OF BLACKTOP ROAD

SDBC :-Semi Dense Bituminous Concrete

BM:-Bituminous Macadam

WMM :-Wet Mix Macadam

GSB:-Granular sub-base

## BAGRU FSTP

- 1. All dimensions are in 'nm' unless mentioned otherwise.
  2. All dimensions are checked and co-related with the architectural drawings and any discrepancy or omission shall be brought to the notice.
  3. This is the property of BORDA/CDD & is not to be copied or produced anywhere without their permission.
  4. EGL = Existing Ground Level +96.5
  5. Grade of concrete proposed (M15, M20 M25). It is recommended to use Sulphate Resistance Cennent (SRC).
  6. Ri indicates Register:
  7. SC indicates Steep Chamber
  7. SC indicates Studge drying Bed
  7. Pid indicates Studge drying Bed
  7. Pid indicates Shabilization Reactor
  7. Findicates Planted Orawel Filter
  7. Pid indicates Anaerobic Filter
  7. Pid indicates Planted Gravel Filter
  7. Pid indicates Sperator Room
  7. Vise UPVC riphes (25.4mm, 5.5mm, 110mm & 150 mm dia (1", 2", 4" & 6")) which can withstance
  7. Use UPVC riphes (25.4mm, 5.5mm, 110mm & 150 mm dia (1", 2", 4" & 6")) which can withstance
- As per the layout plan provided treatment structures inner plastering (walls and base) of 20mm thick is

REMARKS SIGNATUR

 ${
m ROAD}:$ -Typical Cross Section of Blacktop Road

## BAGRU/FSTP/CD/ROAD

PROJECT NAME **BAGRU FSTP** 


## NIUA, DLB and Nagar Palika Bagru


Consortium for DEWATS
Dissemination
Society


CLIENTS CONSULTANT:


Survey No.205,
Opp. Beedi Workers Colony,
Kommaghatta Road, Bandemath
BANGALORE - 560 060
KARNATAKA.

SCALE: NTS	22/02/2018	DATE	Ritesh Kumar Suman	DRAWN BY	
SHEET 19 O	22/02/2018	DATE	Praveen. N	CHECKED BY	
SHEET 19 OF 27 SHEETS	22/02/2018	DATE	Praveen. N	APPROVED BY	

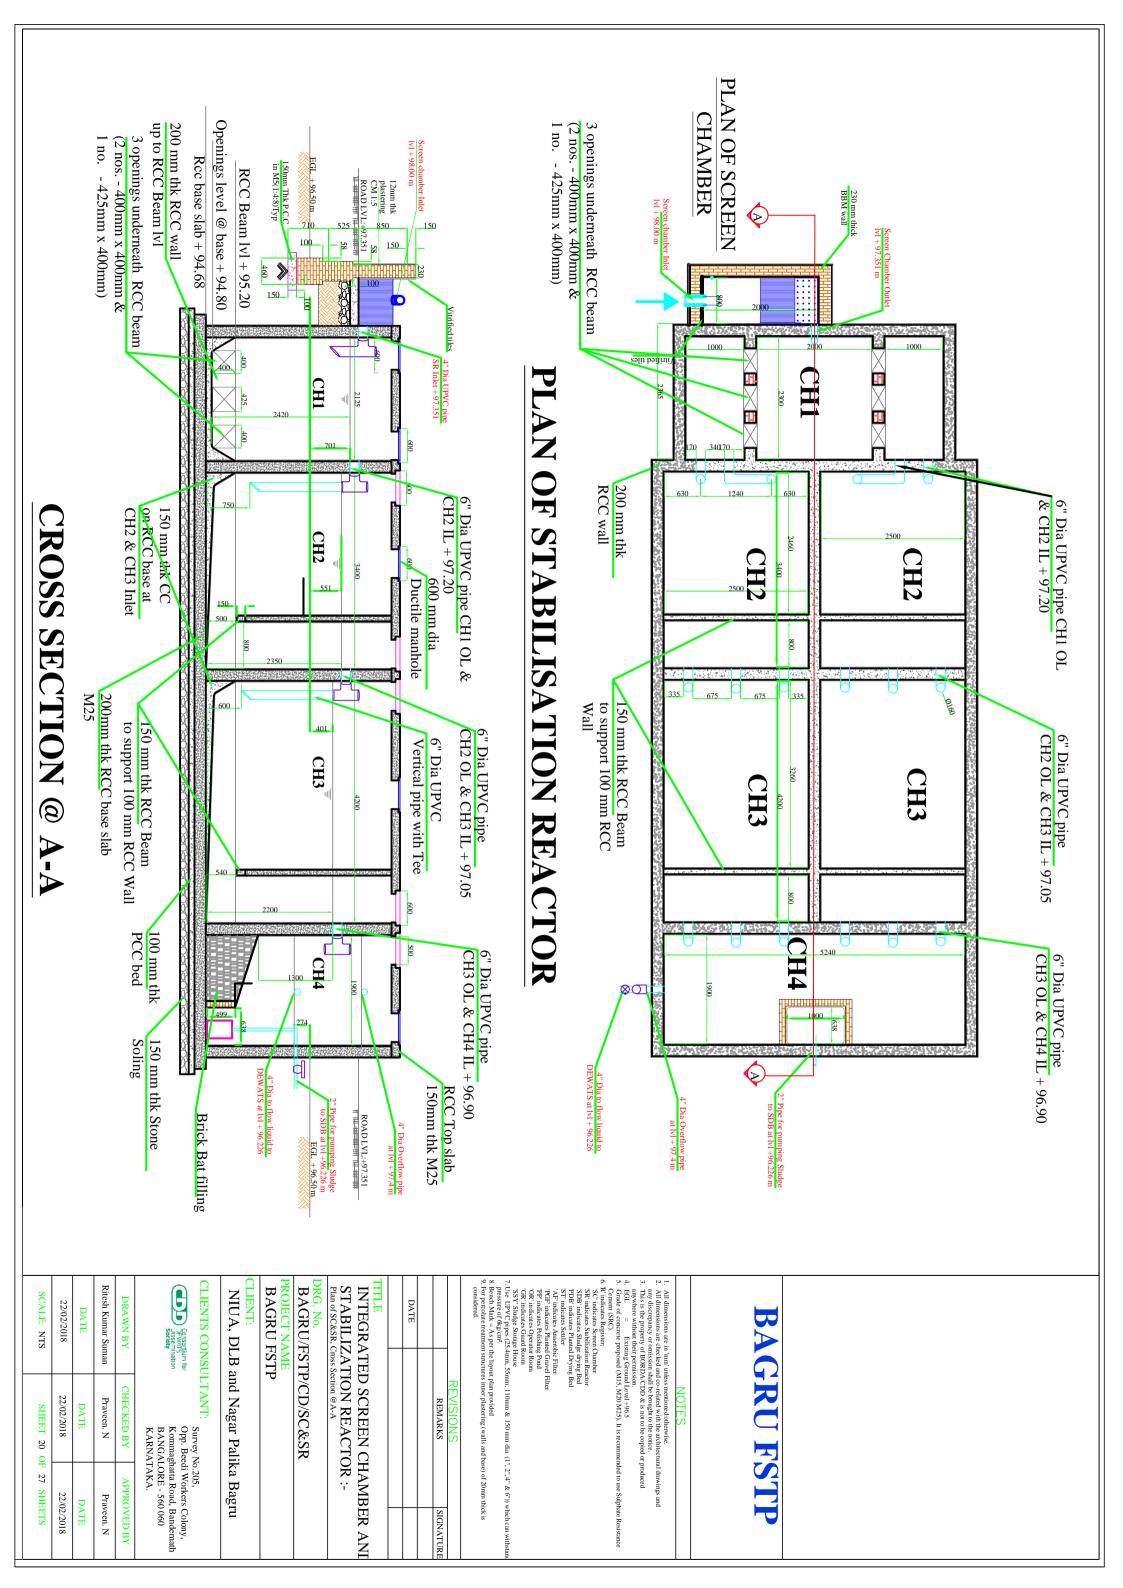


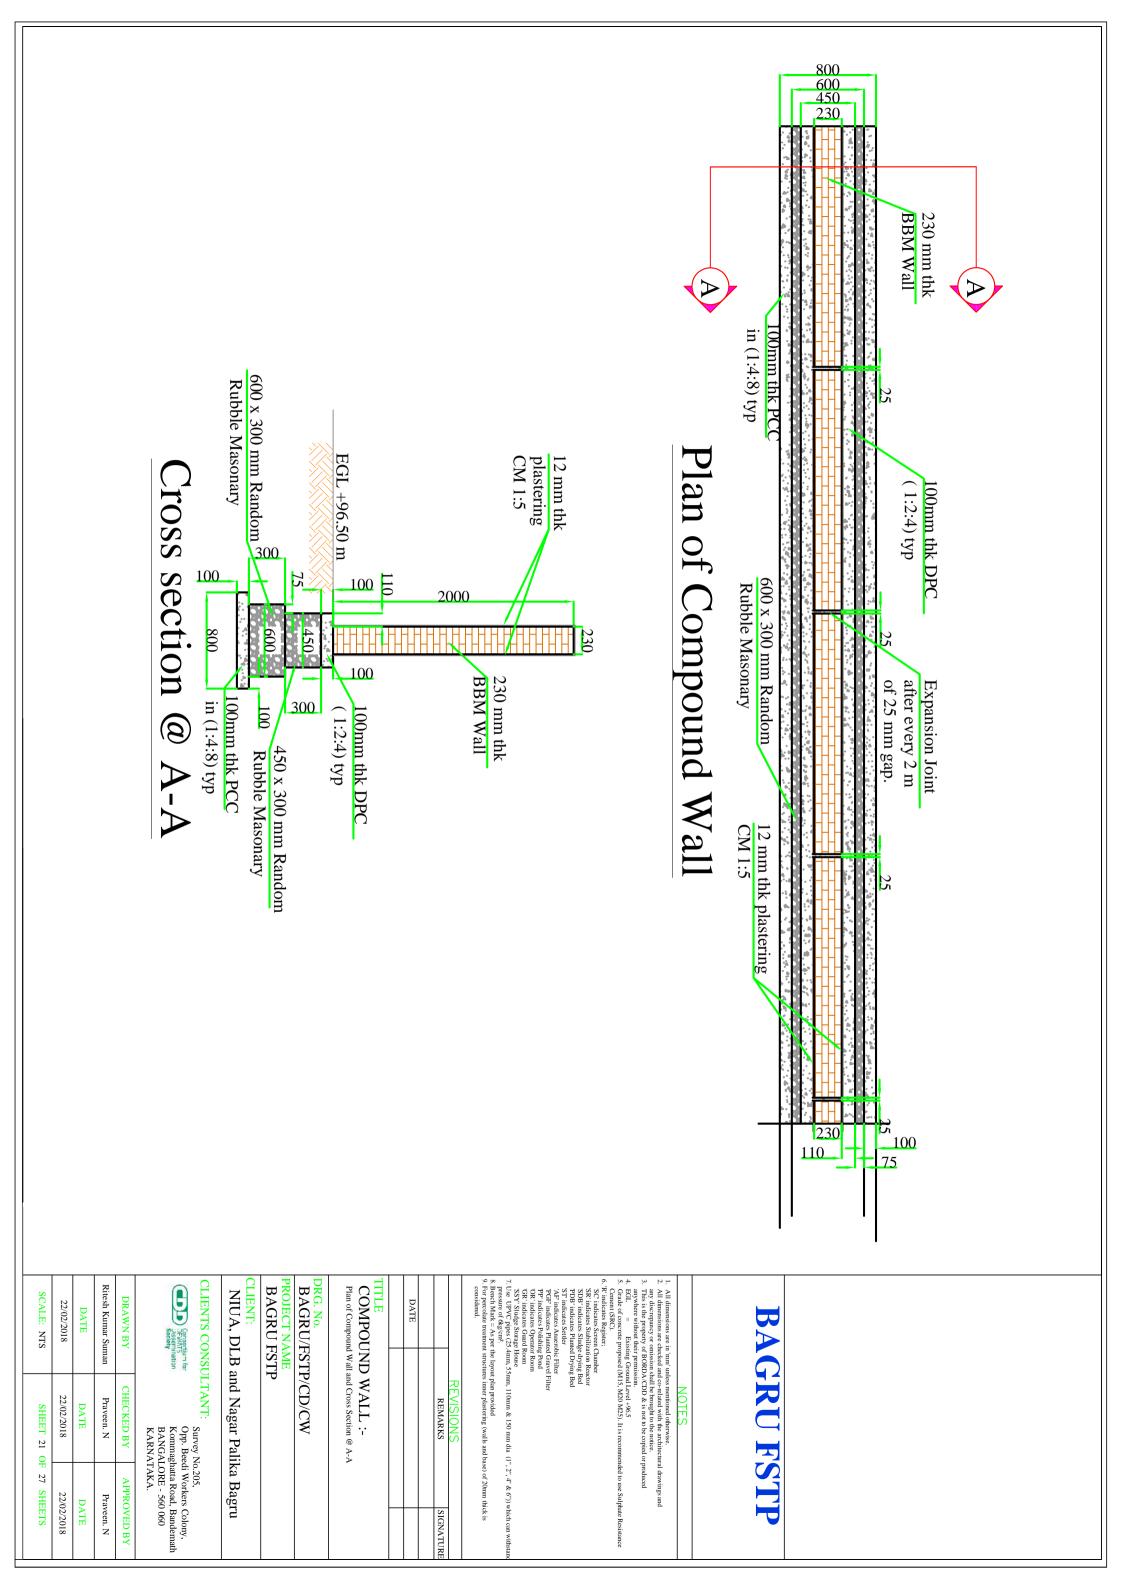

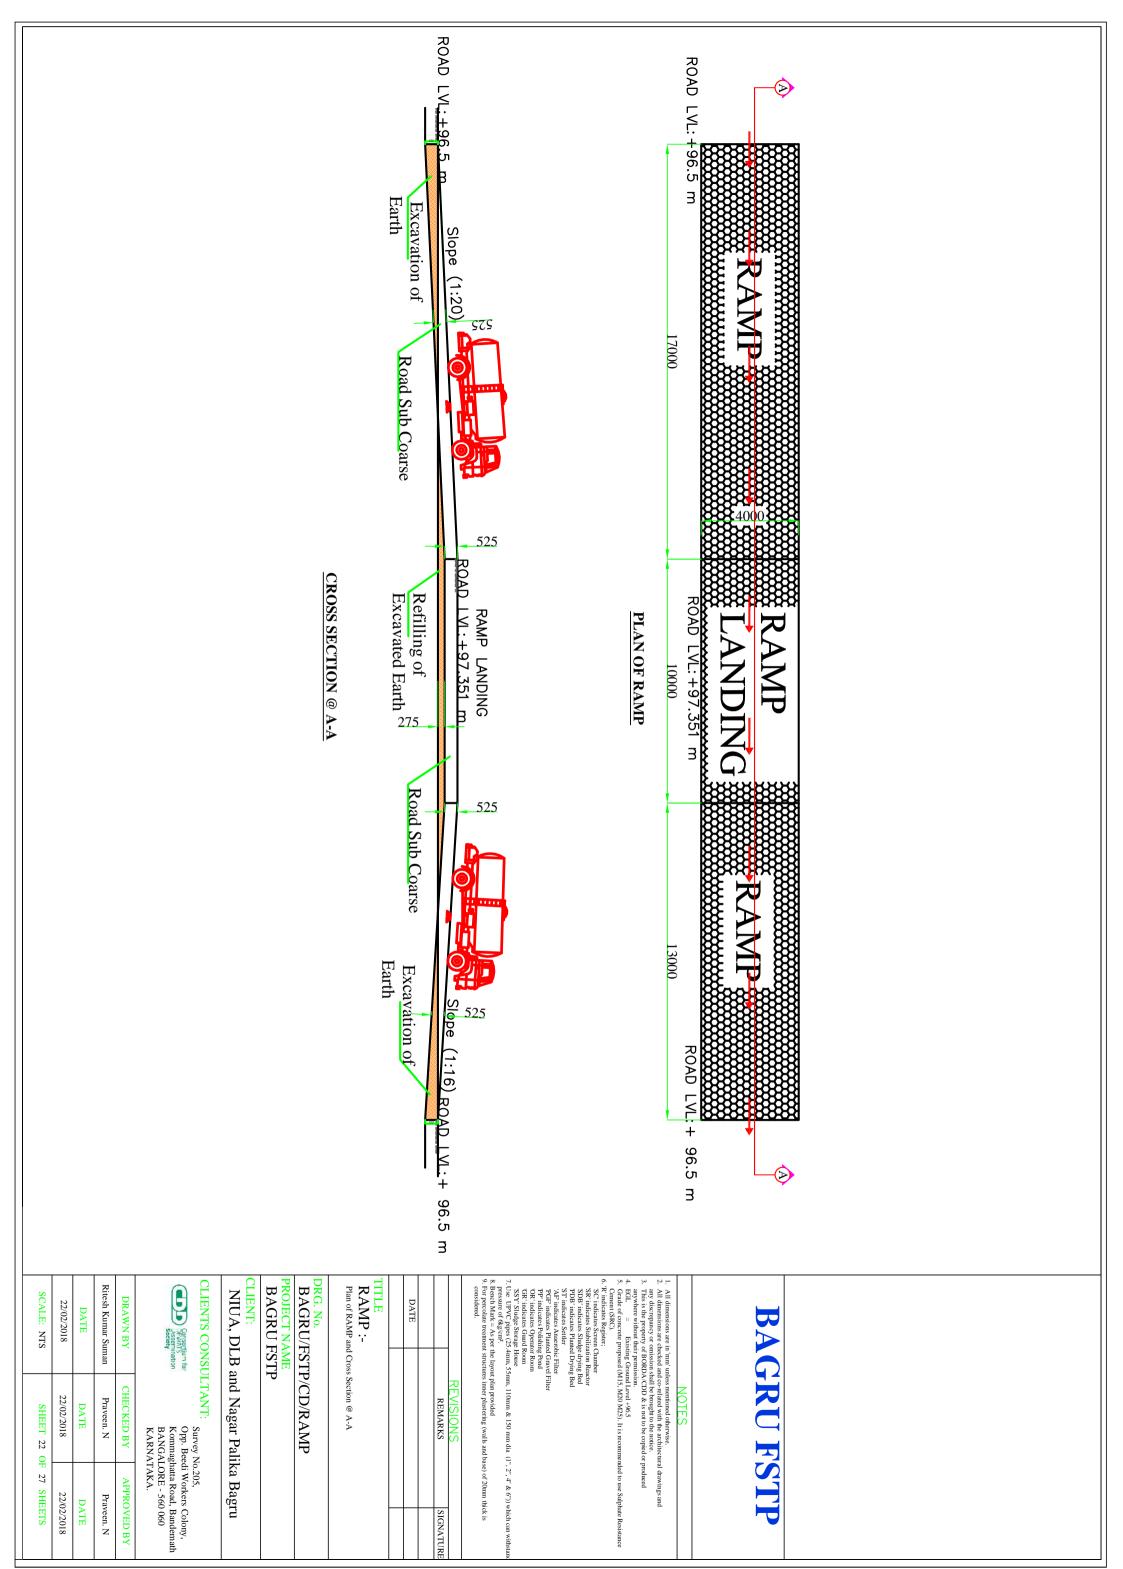

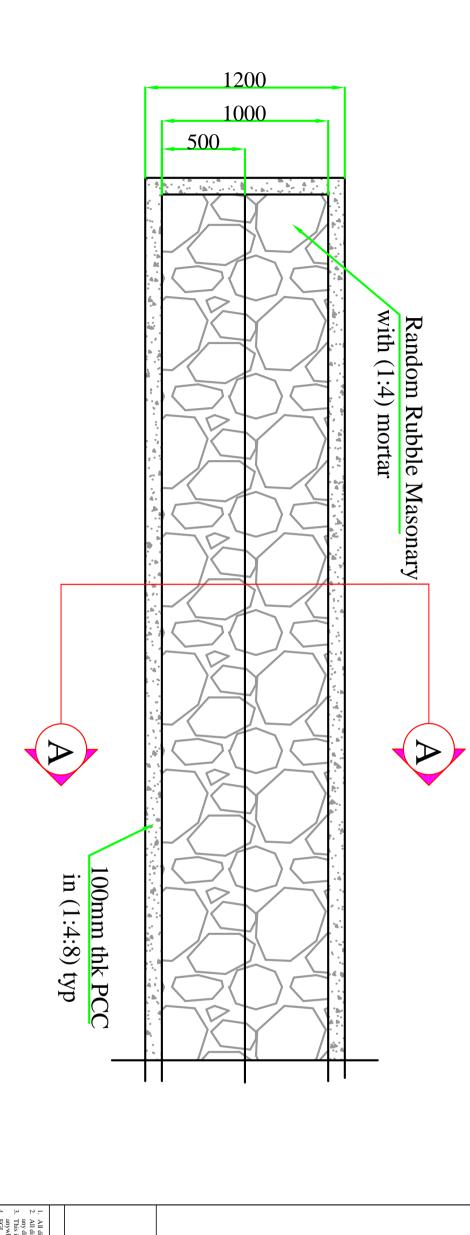

## Plan of Retaining Wall

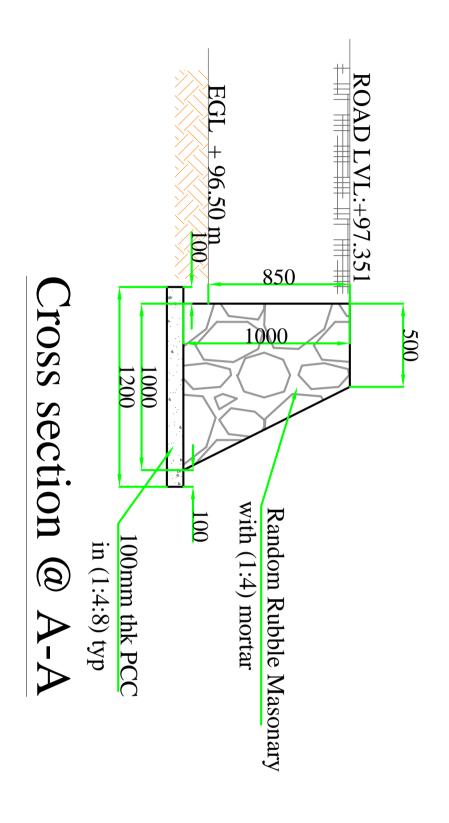

## NOTES

- 1. All dimensions are in 'mm' unless mentioned otherwise.
  2. All dimensions are checked and co-related with the architectural drawings and any discrepancy or omission shall be brought to the notice.
  3. This is the property of BORDA/CDD & is not to be copied or produced any discrepancy or omission shall be brought to the notice.
  4. EGL = Existing Ground Level +96.5
  5. Grade of concrete proposed (M15, M20 M25). It is recommended to use Sulphate Resistance Cement (SRC).
  6. R' indicates Register;
  7. SC indicates Register;
  7. SC indicates Surface Oryting Bed
  7. ST indicates Sulphated Drying Bed
  7. ST indicates State of Gravel Filter
  7. Findicates Planted Drying Bed
  7. Findicates Planted Brown
  7. State of State o

DATE		
	REMARKS	REVISIONS
	SIGNATURE	

## **RETAINING WALL:**

Plan of Retaining wall and Cross Section @ A-A

## **BAGRU FSTP**

DRG. No. BAGRU/FSTP/CD/RW

Consortium for Dissemination Society

NIUA, DLB and Nagar Palika Bagru

CLIENTS CONSULTANT:

CHECKED BY Praveen. N Survey No.205,
Opp. Beedi Workers Colony,
Kommaghatta Road, Bandemath
BANGALORE - 560 060
KARNATAKA. APPROVED BY Praveen. N

Ritesh Kumar Suman

22/02/2018 DATE

22/02/2018

22/02/2018


23


27

DATE


DATE

DRAWN BY

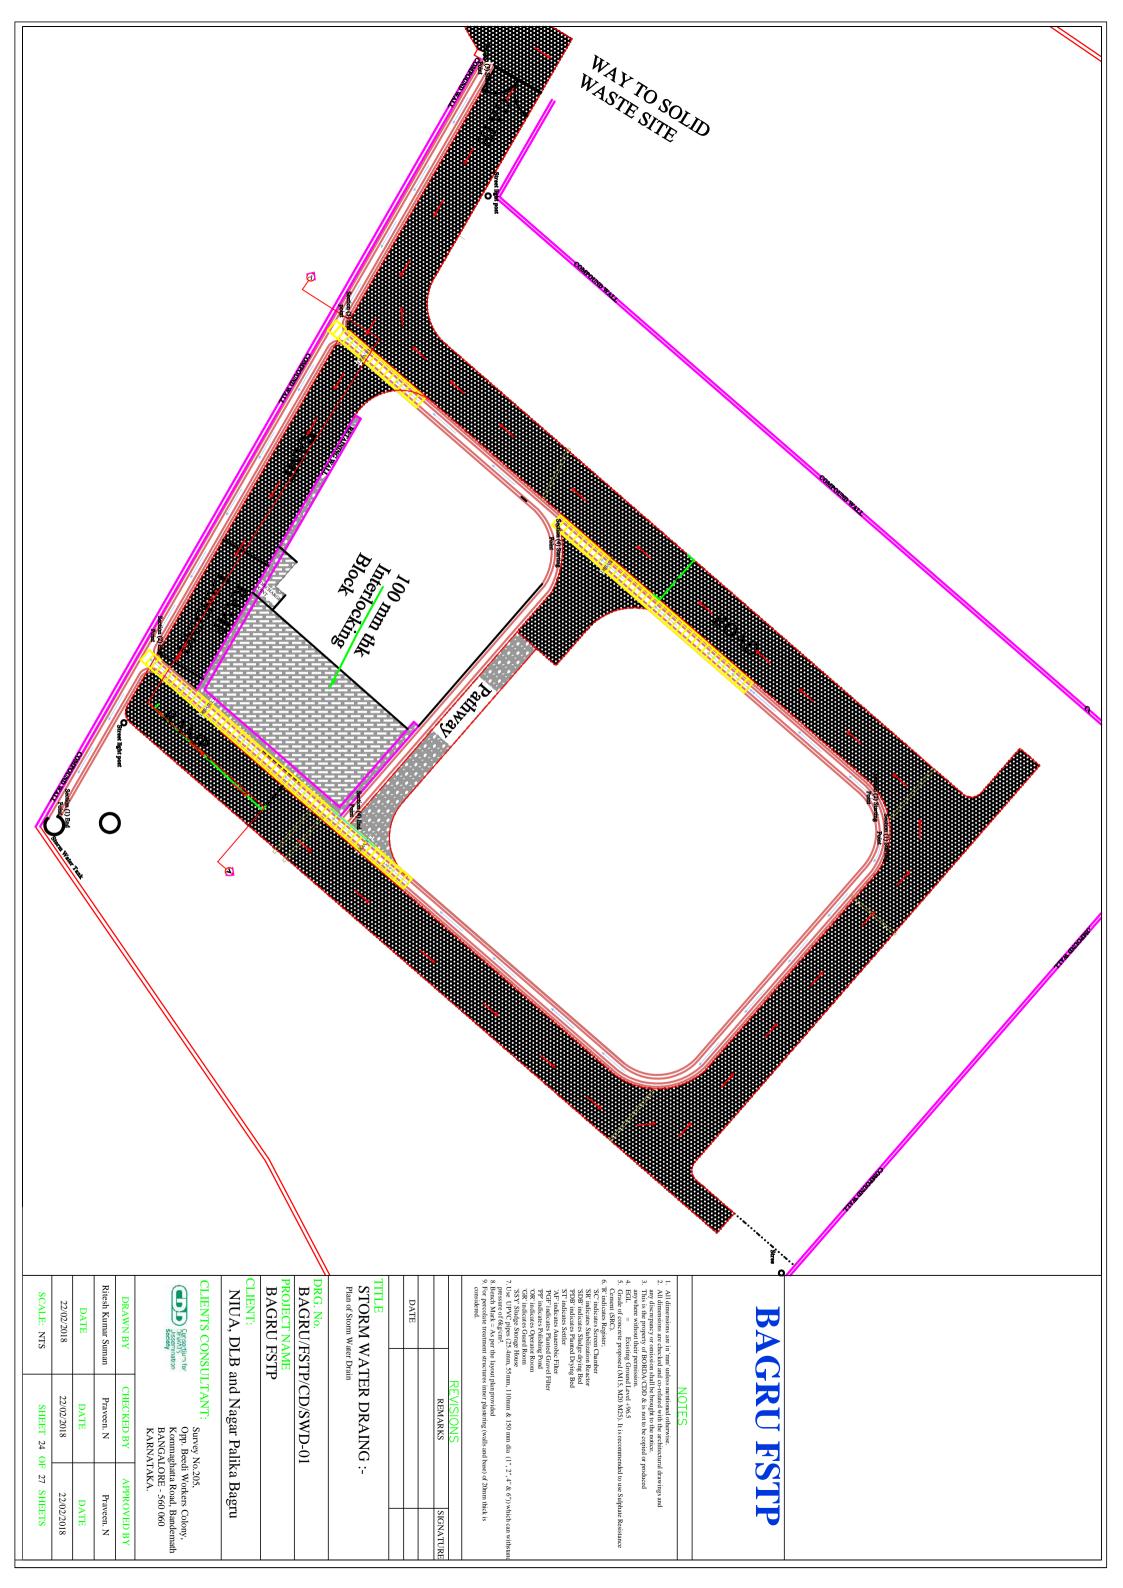


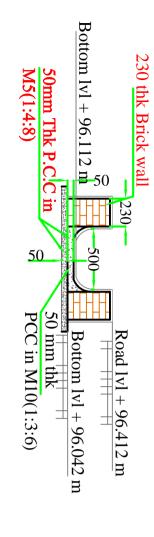


## Section (1) Starting Point

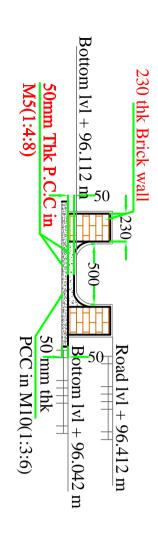


## Section (2) Starting Point

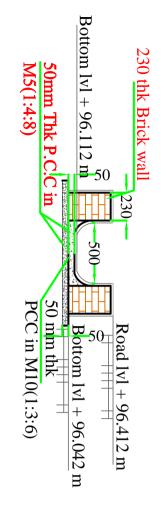



## Section (3) Starting Point

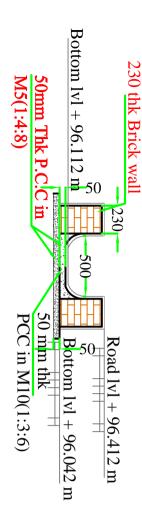


Section (4) Starting Point

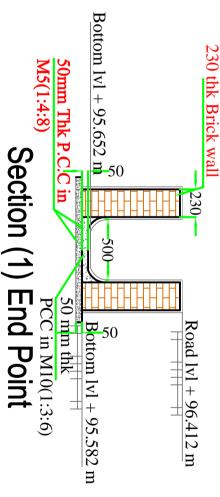

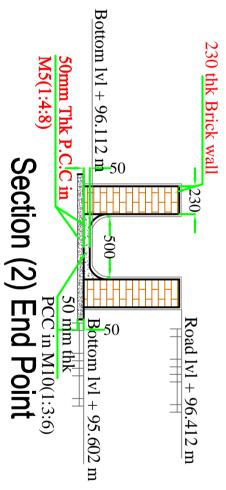

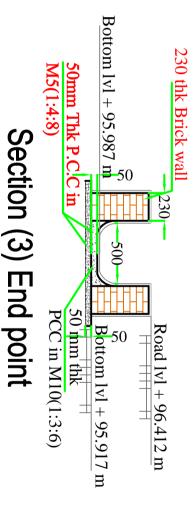

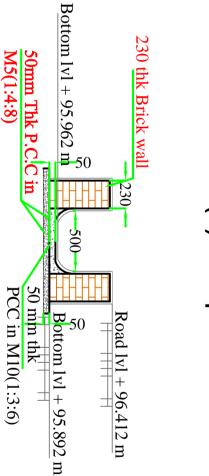

## Section (4) End Point

- All dimensions are in 'mm' unless mentioned otherwise.

  All dimensions are checked and co-related with the architectural drawings and any discrepancy or omission shall be brought to the notice.

  This is the property of BORDA/CDD & is not to be copied or produced anywhere without their permission.

  EGL = Existing Ground Level +96.5

  Grade of concrete proposed (M15, M20 M25). It is recommended to use Sulphate Resi

- S.C. indicates Register:
  S.C. indicates Series (Namber)
  S.R. indicates Suchlization Reactor
  S.R. indicates Suchlization Reactor
  S.R. indicates Suchlization Reactor
  S.R. indicates Such Planed Drying Bed
  P.D.B. indicates Planed Grying Bed
  S.T. indicates Setter
  A.F. indicates Setter
  A.F. indicates Planed Gravel Filter
  P.G.F. indicates Planed Gravel Filter
  P.P. indicates Planed Gravel Filter
  S.R. indicates Operator Room
  C.R. indicates Operator Room
  S.S.Y. Sludge Storage House
  S.S.Y. Sludge Storage House
  S. Indicates Carter the Instituted Interval Advanced Interval Int

nsidered.		
	REVISIONS	
	REMARKS	SIGNATURE
DATE		

## STORM WATER DRAING:-Section of Storm Water Drain

**BAGRU FSTP** 

## DRG. No. BAGRU/FSTP/CD/SWD-02

CLIENTS CONSULTANT:

## NIUA, DLB and Nagar Palika Bagru

Consortium for DEWATS
Dissemination
Society

Survey No.205,
Opp. Beedi Workers Colony,
Kommaghatta Road, Bandemath
BANGALORE - 560 060

Ritesh Kumar Suman CHECKED BY Praveen. N DATE KARNATAKA. APPROVED BY Praveen. N DATE

DRAWN BY


22/02/2018

22/02/2018

SHEET

25 O<sub>F</sub> 27

SHEETS 22/02/2018

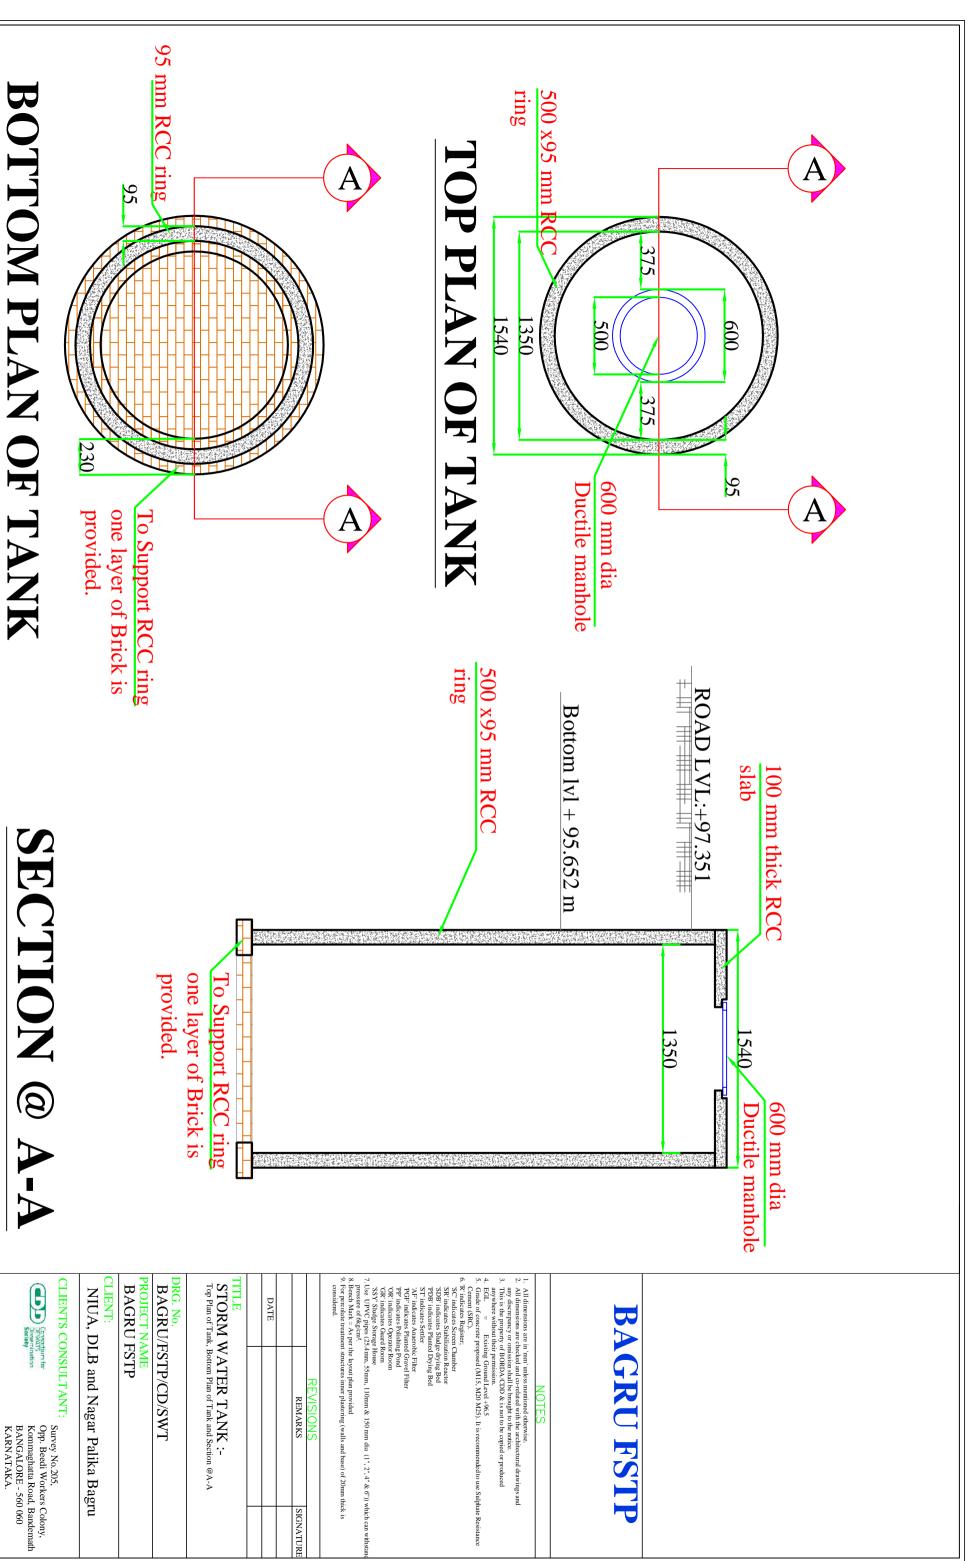

Ritesh Kumar Suman

Praveen. N

DRAWN BY

CHECKED BY

APPROVED BY

SIGNATURE

SCALE: NTS

SHEET 26 OF

27 SHEETS


22/02/2018


22/02/2018

22/02/2018 DATE


DATE

## REGISTER

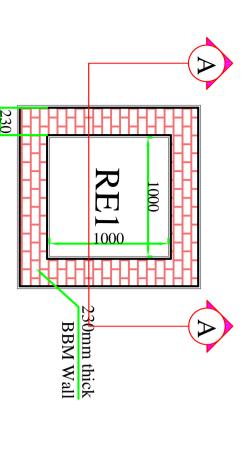

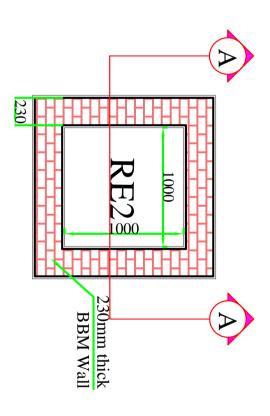

## Plan of Register

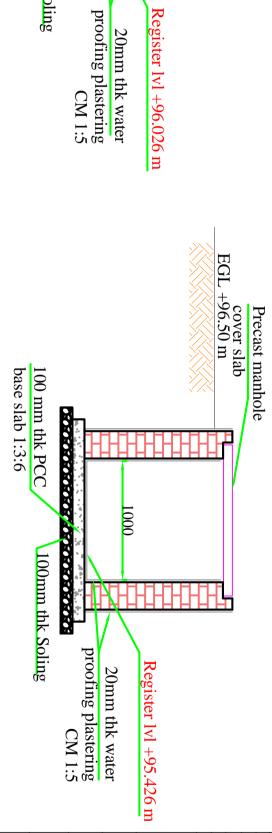

cover slab EGL +96.50 m

000

Precast manhole

## Cross section @ A-A

base slab 1:3:6 100 mm thk PCC

\$0.00.00.00.00

100mm thk Soling

## **BAGRU FSTP**

- 1. All dimensions are in 'mm' unless mentioned otherwise.
  2. All dimensions are checked and co-related with the architectural drawings and any discrepancy or omission shall be brought to the notice.
  3. This is the property of BORDA/CDD & is not to be copied or produced anywhere without their permission.
  4. EGIL = Existing Ground Level +96.5
  5. Grade of concrete proposed (M15, M20 M25). It is recommended to use Sulphate Resistance Cement (SRC).
  5. Crindicates Register;
  5. Crindicates Sterien Chamber
  5. SPC indicates Sharling format Level +96.5
  8. Tindicates Sharling and Reactor
  5. SPD indicates Sharling drayed Hilter
  FOBF indicates Planted Drying Bed
  7. Tindicates Planted Toying Bed
  7. Tindicates Planted Toying Bed
  7. Findicates Planted Format Hilter
  FOBF indicates Planted Gravel Hilter
  FOBF indicates Planted Toying Toying Toying to the Propriate State of Properties (25.4 mm, 55 mm, 110 mm & 150 mm dia (1", 2", 4" & 6")) which can withs pressure of 6 kg/cm<sup>2</sup>.
  8. Beneh Mark = As pet the layout plan provided
  9. For percolate reatment structures inner plastering (walls and base) of 20 mm thick is considered.

DATE		
	REMARKS	REVISIONS
	SIGNATURE	

REGISTER:Plan of Register and Cross Section @ A-A

DRG. No.
BAGRU/FSTP/CD/REGISTER

## PROJECT NAME BAGRU FSTP

## NIUA, DLB and Nagar Palika Bagru

## CLIENTS CONSULTANT: Consortium for DEWATS Jissemination

Survey No.205,
Opp. Beedi Workers Colony,
Kommaghatta Road, Bandemath
BANGALORE - 560 060
KARNATAKA.

22/02/2018	DATE	Ritesh Kumar Suman	DRAWN BY	
22/02/2018	DATE	Praveen. N	CHECKED BY	
22/02/2018	DATE	Praveen. N	APPROVED BY	

NTS

SHEET

27 Q 27

SHEETS